

CONSTRUCTION DRAWINGS

FOR

PHASE II - ROUTE 133 PUMP STATION IMPROVEMENTS


IN

TOWN OF BROOKFIELD

FAIRFIELD COUNTY, CONNECTICUT

Project No. 190093201

CLIENT / OWNER
BROOKFIELD WPCA 53A COMMERCE ROAD UNIT 1, BROOKFIELD, CT 06804 TELEPHONE: 203-775-7319 CONTACT: ROGER PRINZ
CIVIL ENGINEER
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ELECTRICAL ENGINEER
KEYSTONE ENGINEERING GROUP, INC. 3936 QUAKER BRIDGE ROAD HAMILTON, NJ 08619 TEL: 609-512-5803 CONTACT: HALEY SCOTT, E.I.T.
STRUCTURAL ENGINEER
INTEGRAL ENGINEERING SERVICES, PLLC 27 MAIN STREET DOBBS FERRY, NY 10522 TEL: 914-774-0343 CONTACT: SIRUS MIANDOABI, P.E.

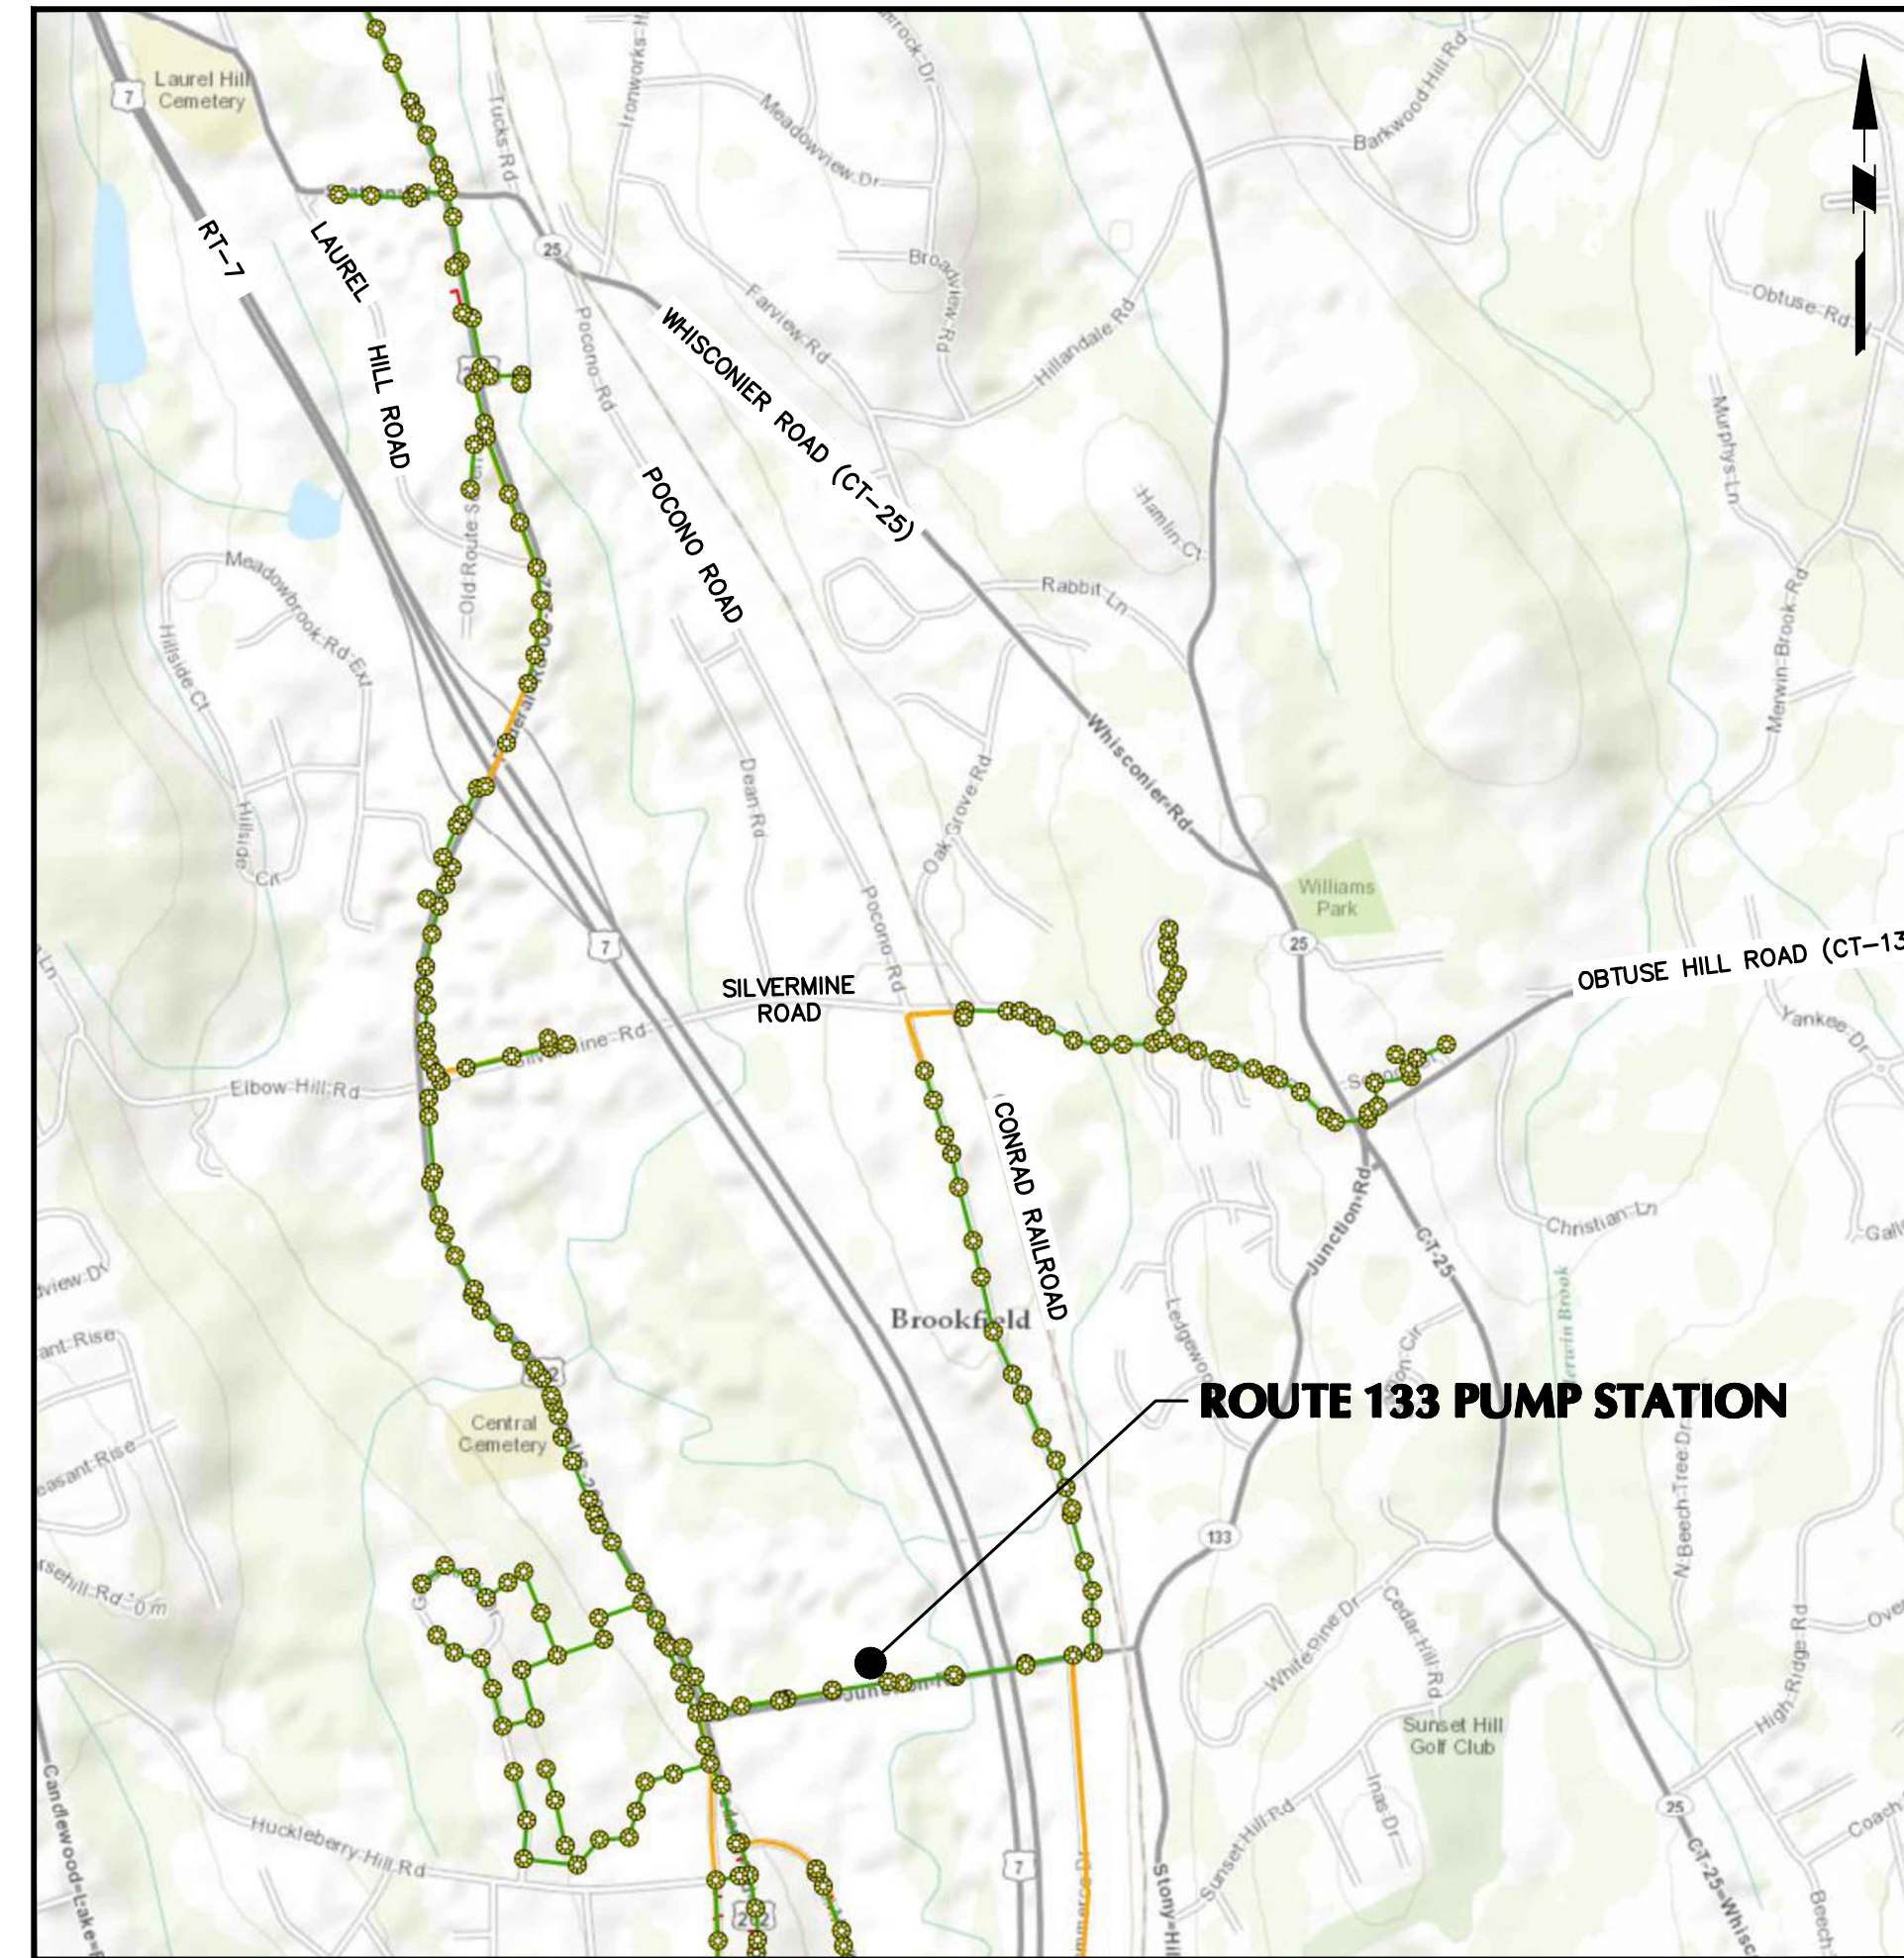

LOCATION MAP

N.T.S.

DRAWING LIST		
CIVIL (LANGAN)		
DRAWING NO.	PAGE NO.	DRAWING TITLE
CS001	1 OF 4	COVER SHEET
CU101	2 OF 4	UTILITY PLAN
CU501	3 OF 4	CONSTRUCTION DETAILS (1 OF 2)
CU502	4 OF 4	CONSTRUCTION DETAILS (2 OF 2)
ELECTRICAL AND HVAC (KEYSTONE)		
DRAWING NO.	PAGE NO.	DRAWING TITLE
ED-101	1 OF 7	ELECTRICAL DEMOLITION PLAN AND SINGLE LINE
E-001	2 OF 7	ELECTRICAL LEGEND AND SYMBOLS
E-100	3 OF 7	ELECTRICAL SITE PLAN
E-101	4 OF 7	ELECTRICAL POWER PLAN
E-601	5 OF 7	ELECTRICAL SINGLE LINE DIAGRAM
E-602	6 OF 7	ELECTRICAL INTERCONNECT AND DETAILS
E-603	7 OF 7	ELECTRICAL DETAILS
STRUCTURAL (INTEGRAL ENGINEERING)		
DRAWING NO.	PAGE NO.	DRAWING TITLE
S-001	1 OF 4	GENERAL NOTES
S-002	2 OF 4	PLOT PLAN
S-100	3 OF 4	PLANS
S-200	4 OF 4	SECTIONS & DETAILS

Date	Description	No.
08/28/24	ISSUED FOR REBID	1
05/22/24	ISSUED FOR BID	0
Revisions		

DATE SIGNED
08/20/2024

SIGNATURE
PROFESSOR OF ENGINEERING CT Lic. No. 0019262

LANGAN

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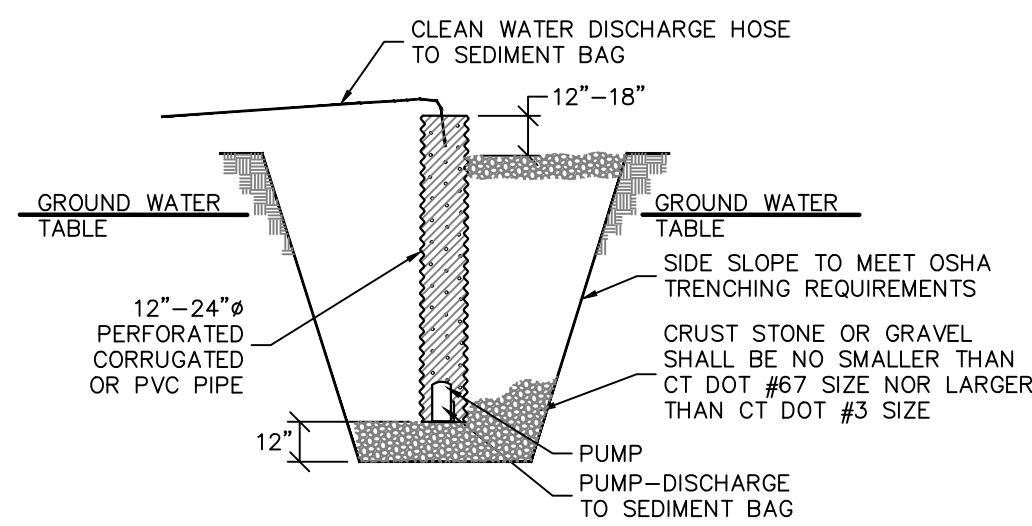
Project
PHASE II - 133 PUMP STATION

FAIRFIELD COUNTY BROOKFIELD CONNECTICUT

Drawing Title
COVER SHEET


Project No. 190093201	Drawing No. CS001
Date MAY 22, 2024	
Drawn By LM	
Checked By CU	
Sheet 1 of 4	

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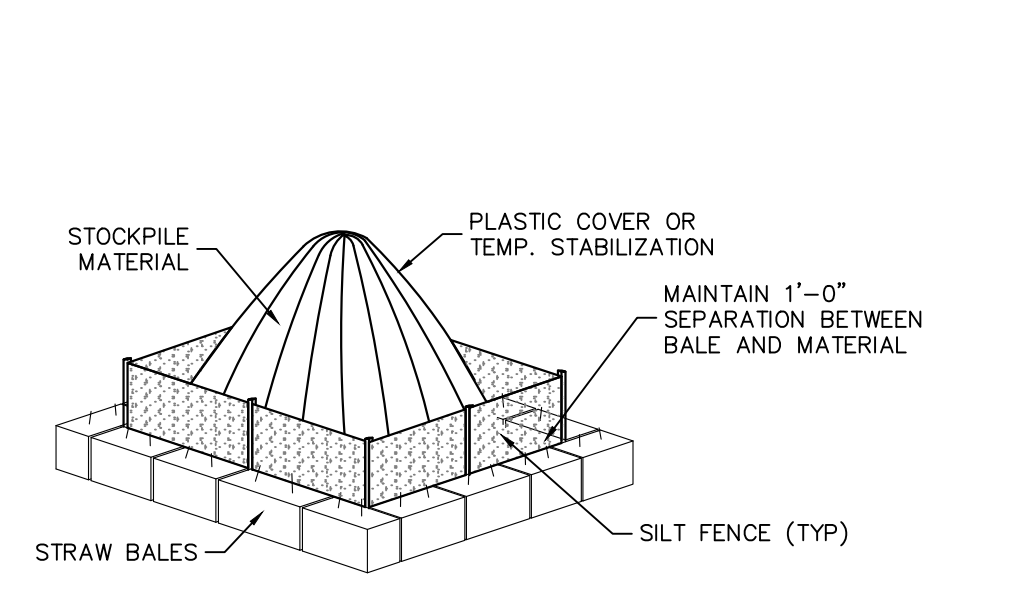
DEWATERING SUMP PIT (IF NEEDED)

SCALE: NTS



SEDIMENT BAG CONTROL SYSTEM

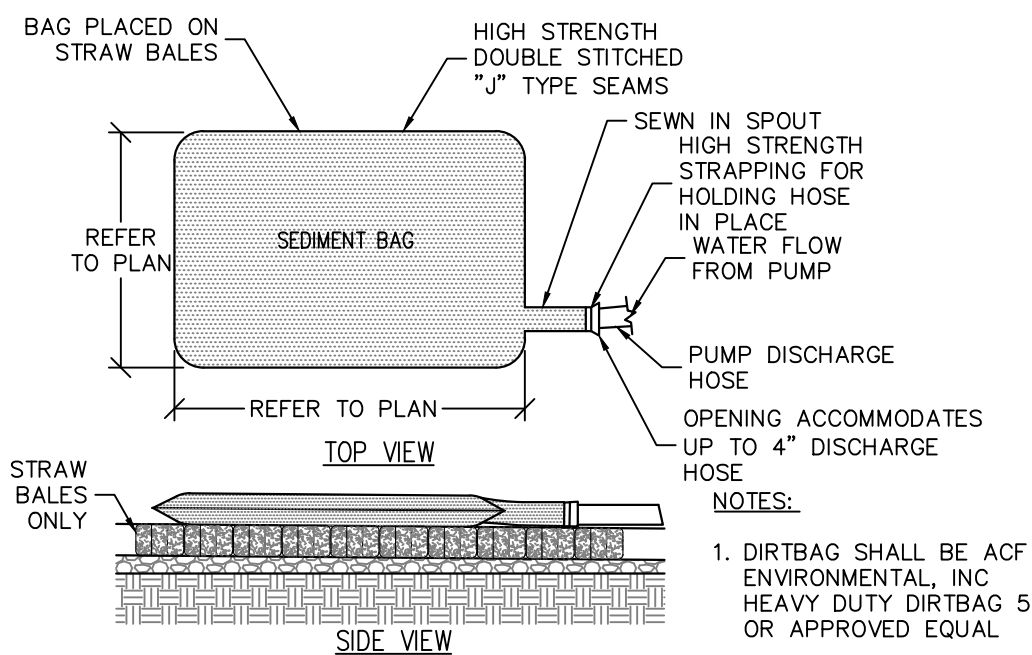SCALE: NTS




STOCKPILE CONTROL

SCALE: NTS


CONSTRUCTION SPECIFICATIONS:

- PIT DIMENSIONS TO BE PROVIDED BY A LICENSED CT ENGINEER RETAINED BY THE CONTRACTOR. ALL DEWATERING, CALCULATIONS AND PLANS SHALL BE SUBMITTED DURING THE SHOP DRAWING REVIEW PROCESS.
- THE STANDPIPE DIAMETER AND NUMBER OF PERFORATIONS SHALL BE COMPATIBLE WITH THE PUMP SIZE BEING USED.
- IF EXCESSIVE MOVEMENT OF FINE SOIL PARTICLES FROM THE SURROUNDING EXISTING SOILS IS ANTICIPATED, A PROPERLY DESIGNED GEOTEXTILE SHALL BE PLACED BETWEEN THE EXISTING SOILS AND THE CRUSHED STONE OR GRAVEL BACKFILL.

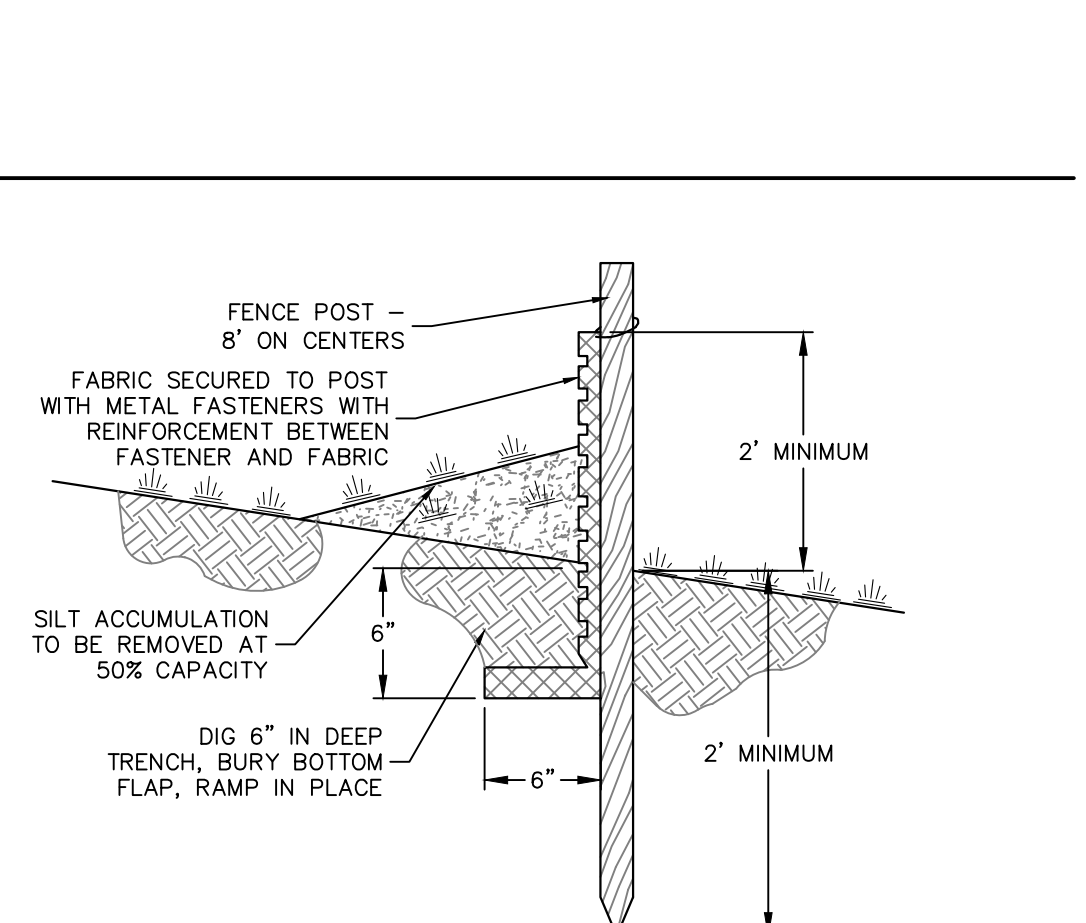


SILT FENCE

SCALE: NTS

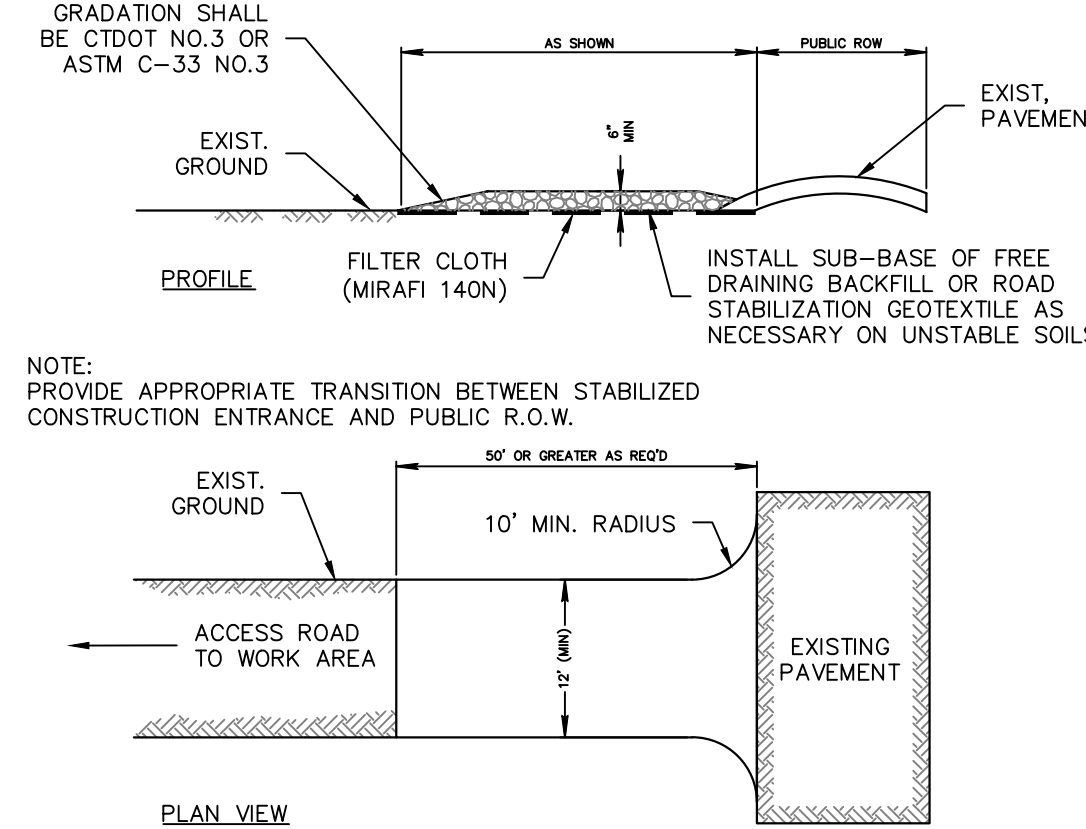


STABILIZED CONSTRUCTION ENTRANCE

SCALE: NTS

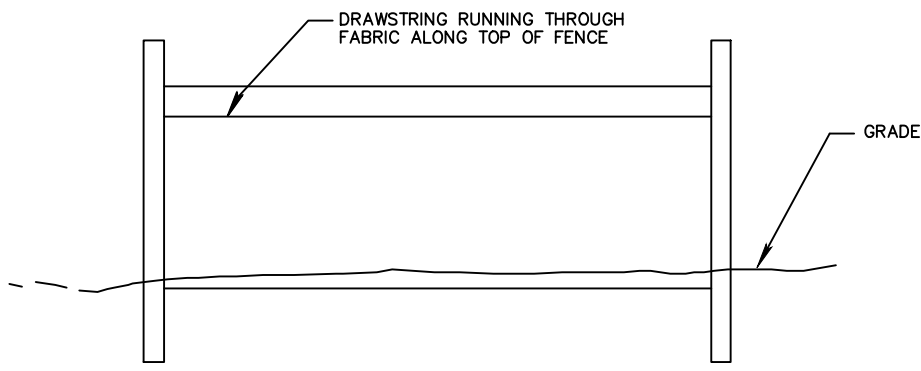


- ALL EXISTING INLETS ALONG THE ALIGNMENT OF THE PROJECT AREA SHALL HAVE INLET FILTERS INSTALLED AS SHOWN.
- CONTRACTOR IS TO CLEAN INLET FILTER AFTER EVERY STORM
 - CONTRACTOR TO REMOVE FABRIC JUST PRIOR TO PAVING.
 - THE PROTECTION DEVICE WILL BE DESIGNED TO CAPTURE OR FILTER RUNOFF FROM THE 1 YEAR, 24 HOUR STORM EVENT AND SHALL SAFELY CONVEY HIGHER FLOWS DIRECTLY INTO THE STORM SEWER SYSTEM.

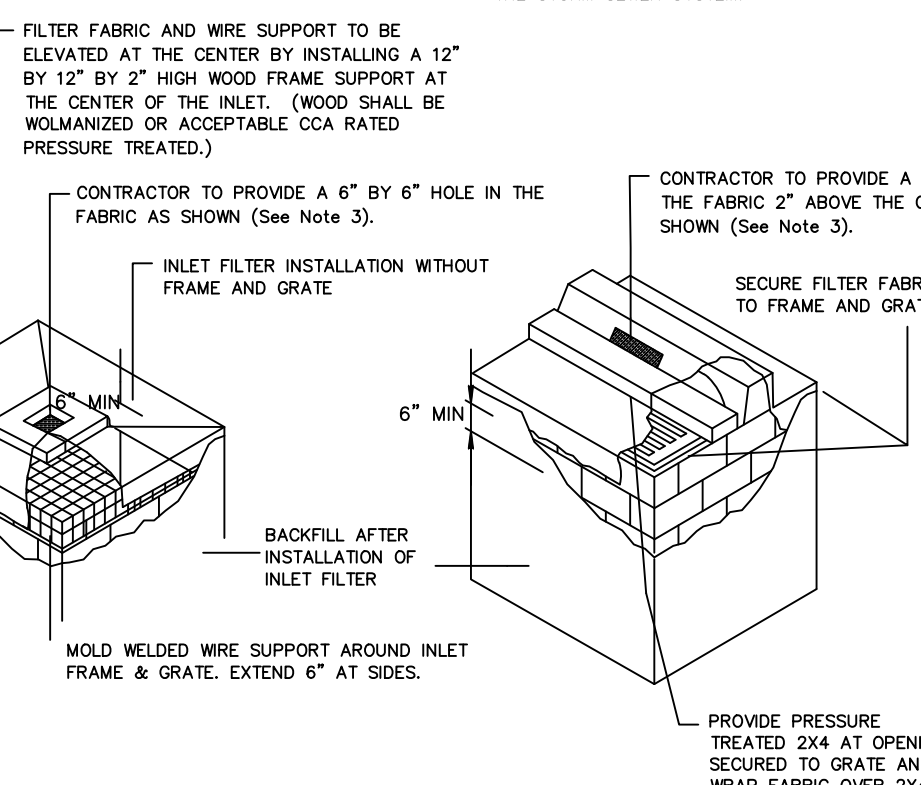

INLET FILTER


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- ### CONSTRUCTION SPECIFICATIONS:
- TREE PROTECTION AREA WILL BE DETERMINED AS PART OF THE PLAN REVIEW PROCESS. EXACT LOCATION, DEPTH AND METHODS OF ROOT PRUNING TO BE DETERMINED IN FIELD BY PROJECT FORESTER.
 - EXACT LOCATION OF TREE PROTECTION AREAS SHALL BE STAKED OR FLAGGED PRIOR TO TRENCHING.
 - TRENCH SHOULD BE BACKFILLED IMMEDIATELY OR INCORPORATED WITH SILT FENCE INSTALLATION.
 - ROOTS SHOULD BE SEVERED BY TRENCHER, VIBRATORY PLOW OR APPROVED EQUIVALENT. ROOTS OVER 1.5" DIAMETER SHOULD BE CLEANLY CUT BY HAND. ROOT PRUNING ADJACENT TO SPECIMEN TREES MAY REQUIRE SOIL REMOVAL BY SUPERSONIC AIR TOOL TO MINIMIZE TREE AND ROOT IMPACTS.

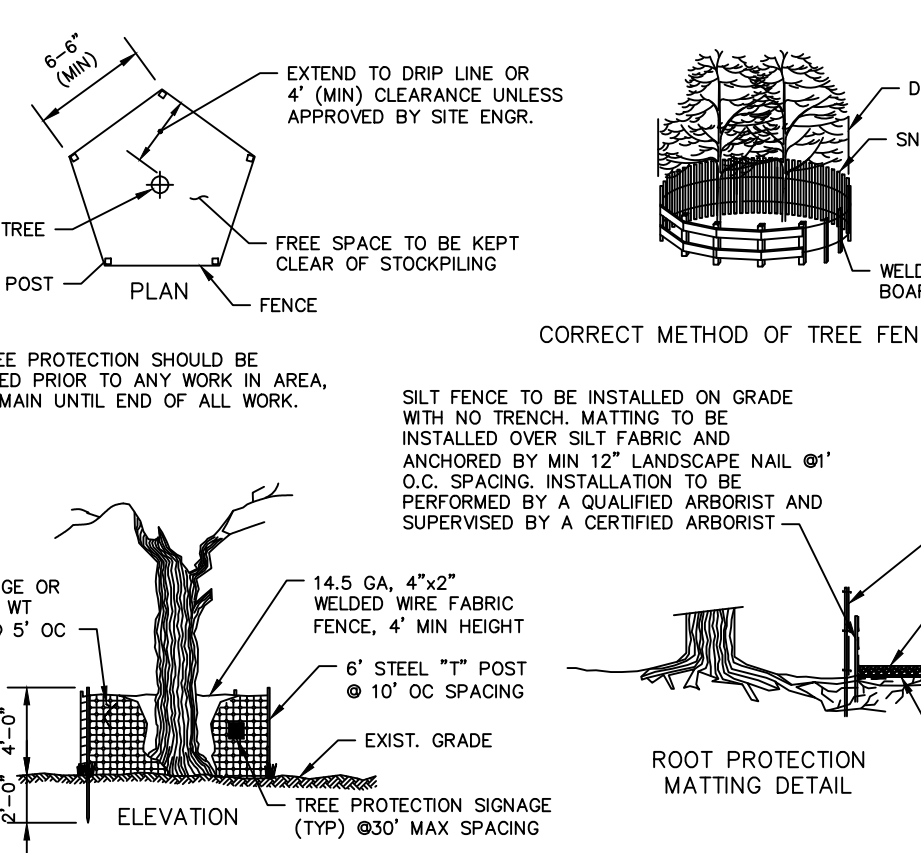TREE/VEGETATION PROTECTION BARRIER



SCALE: NTS



- NOTES:
- NO TRENCH CONTAINING SEWER SHALL BE BACKFILLED UNTIL THE WPCA HAS COMPLETED AN INSPECTION OF AND APPROVED THE WORK.
 - PROVIDE METALLIC MARKING TAPE 18" BELOW GRADE, LABELED "SEWER" OVER THE MAINS, SERVICE LINES & FORCE MAINS.

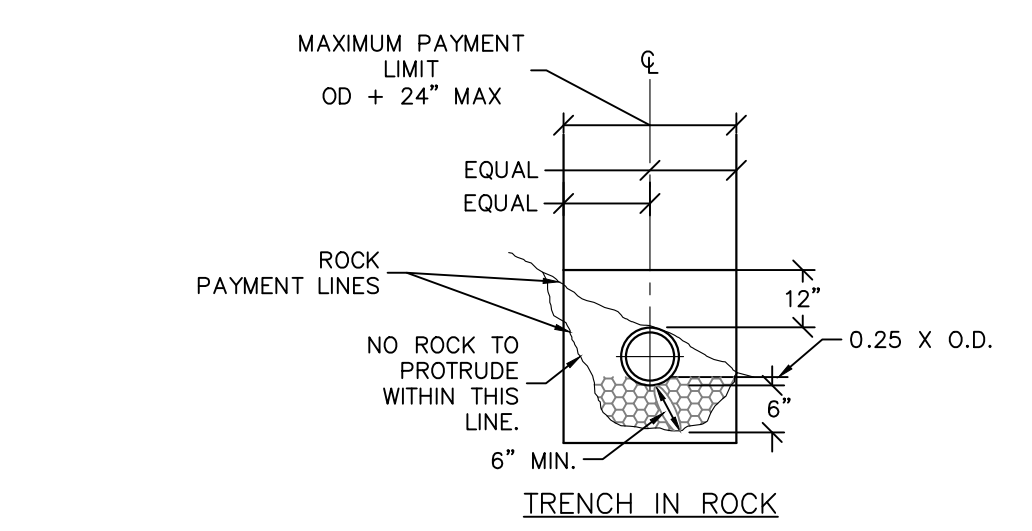TRENCH SECTIONS FOR FLEXIBLE PIPE

SCALE: NTS

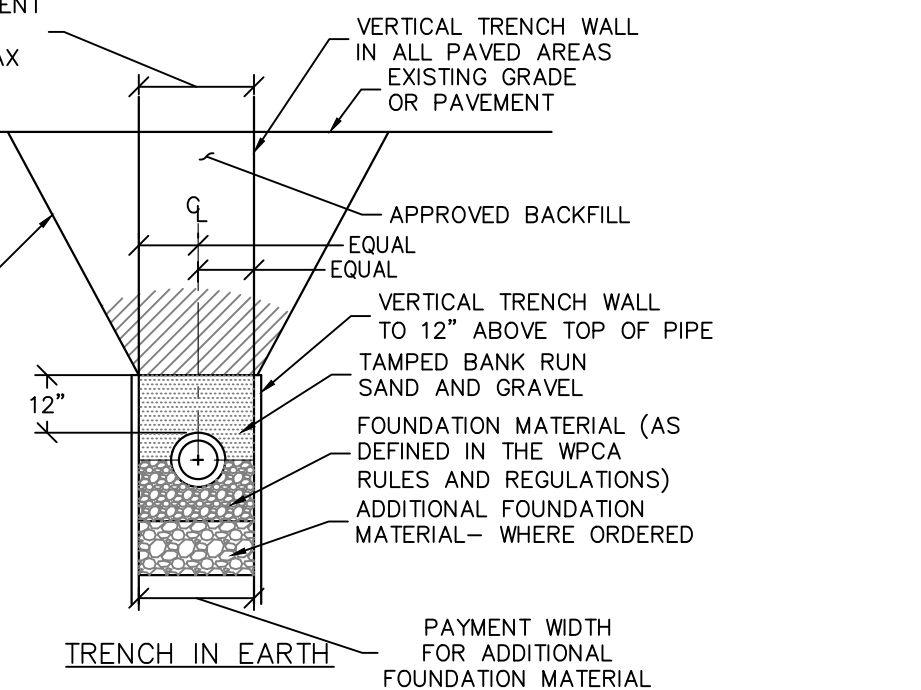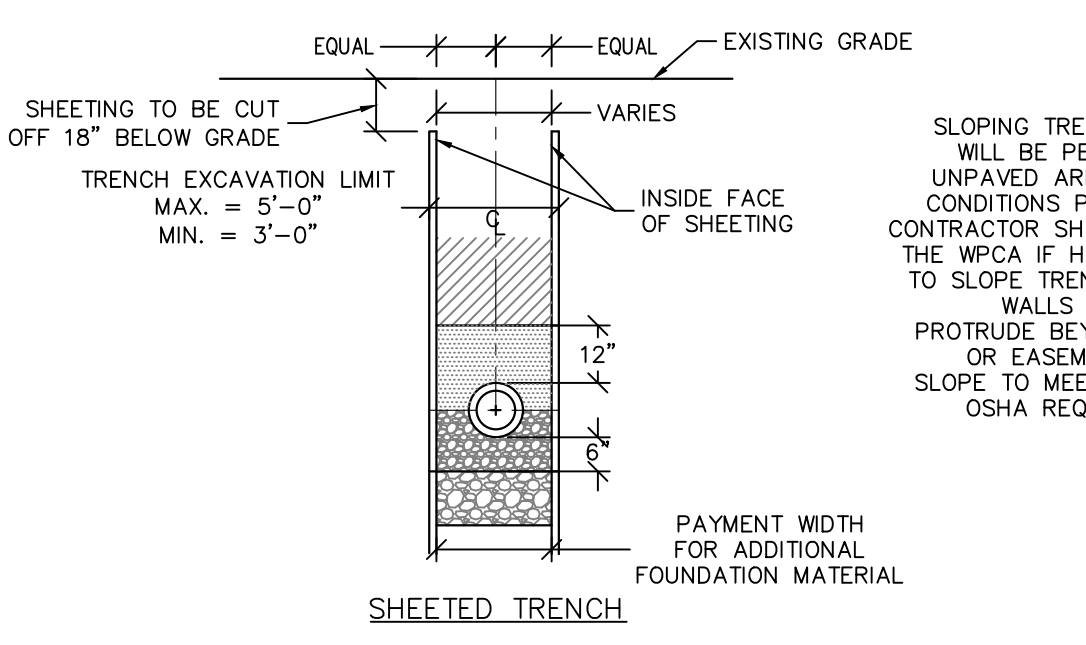

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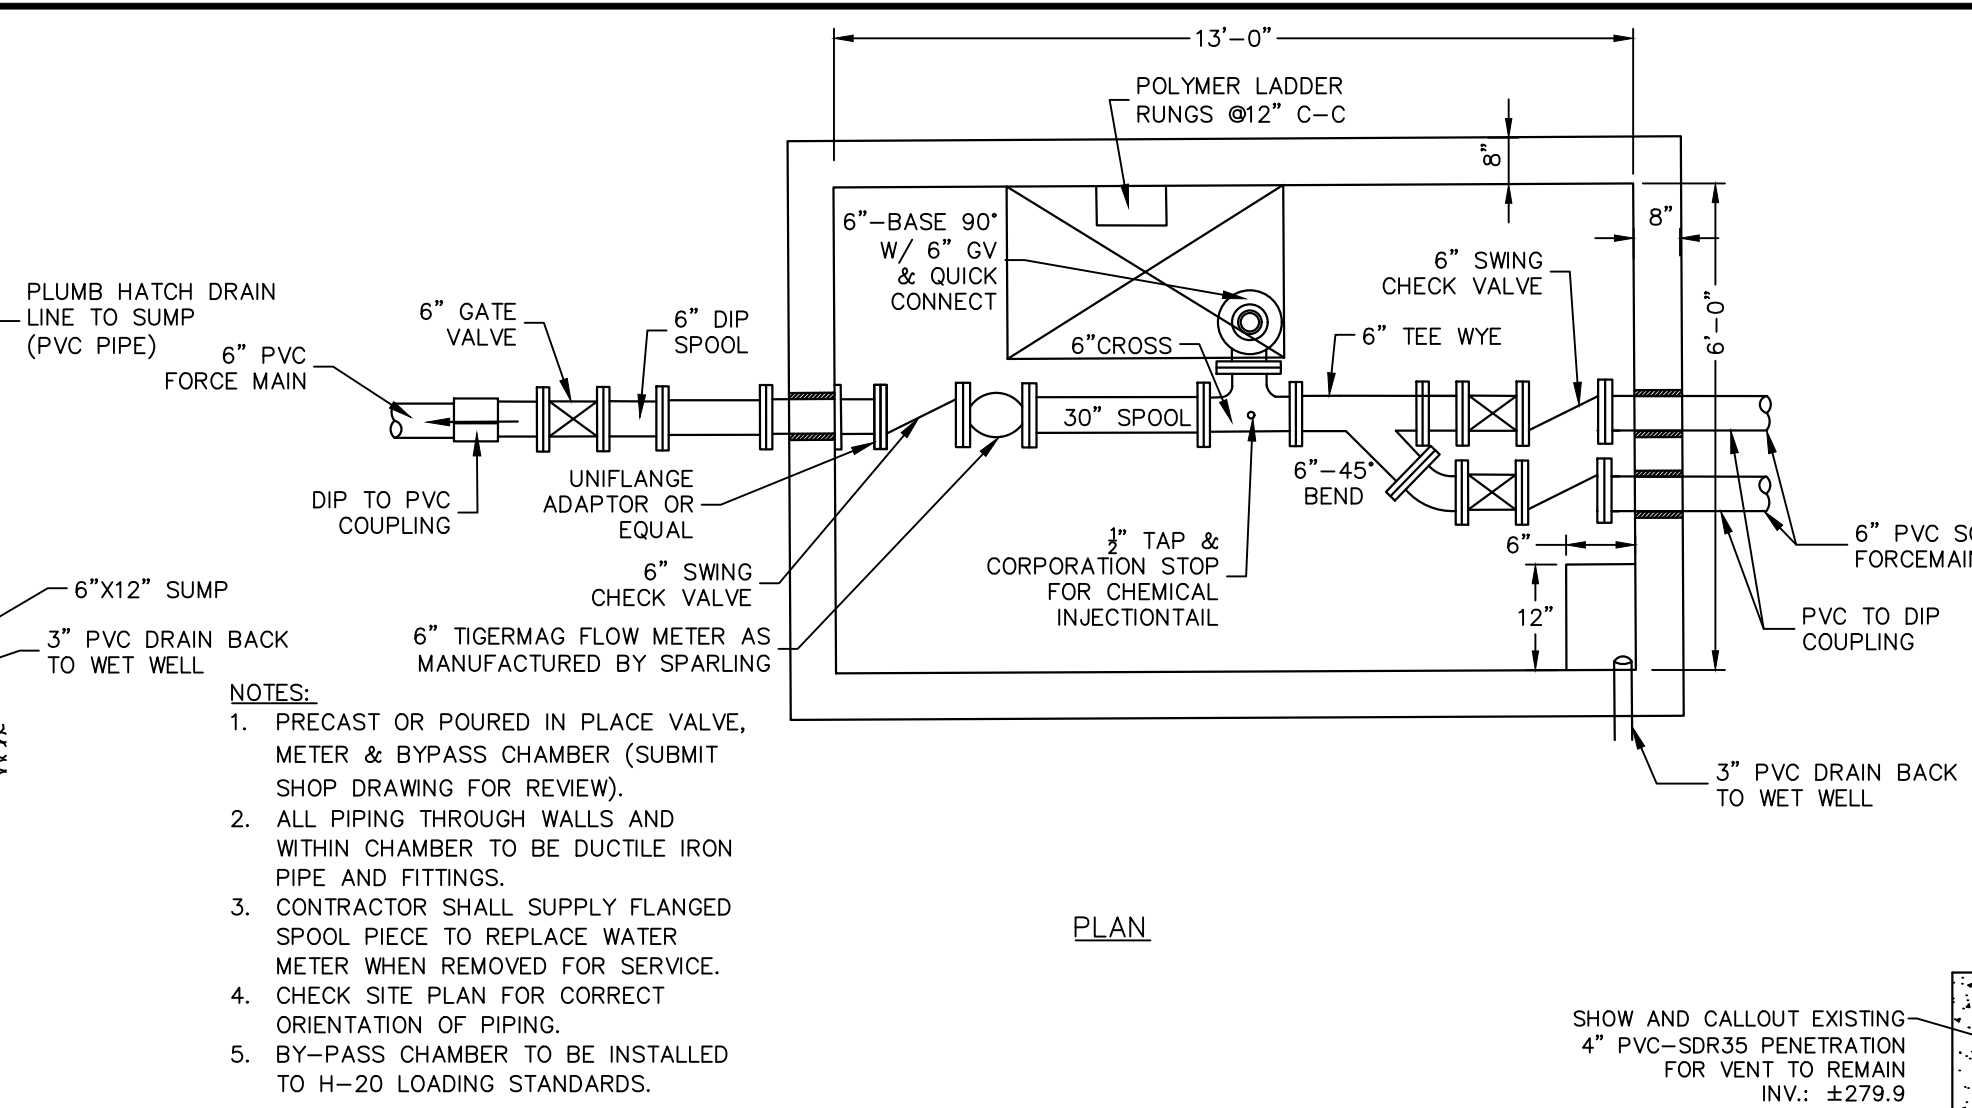
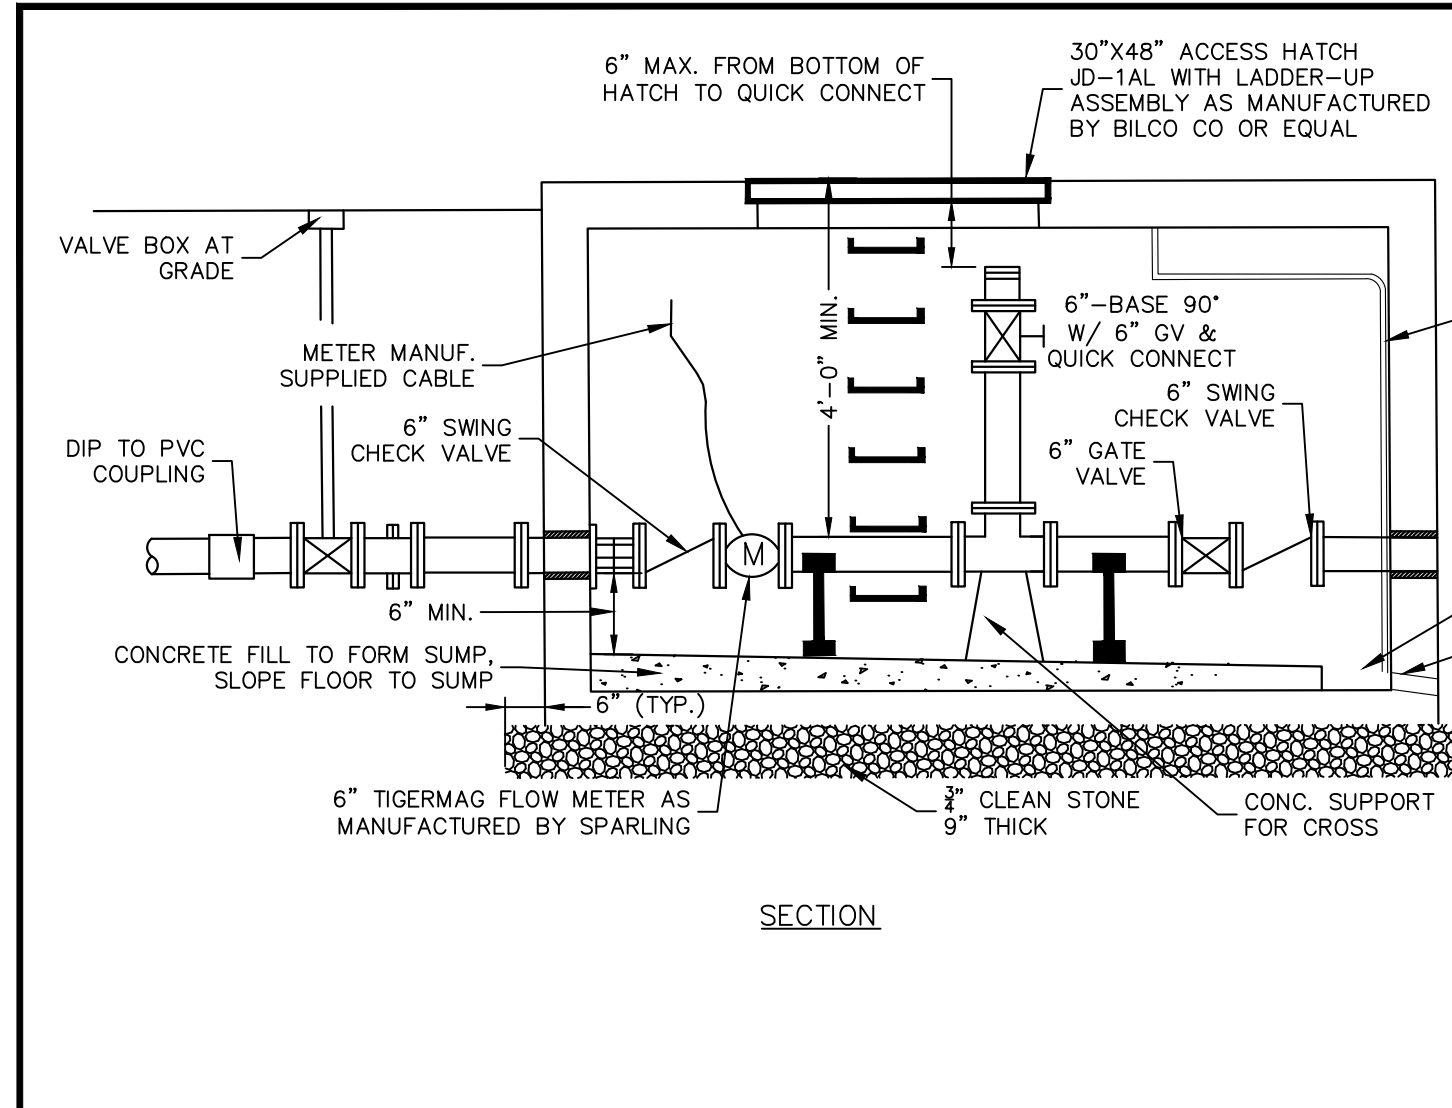
STATE OF CONNECTICUT
OFFICE OF PROFESSIONAL REGULATION
PROFESSIONAL ENGINEER CT Lic. No. 0019262
UTSCHIG JR., P.E.
DATE SIGNED 08/20/2024

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Project
PHASE II - 133 PUMP STATION
BROOKFIELD CONNECTICUT
FAIRFIELD COUNTY



Drawing Title
CONSTRUCTION DETAILS (1 OF 2)

Project No. 190093201
Date MARCH 8, 2024
Drawn By LM
Checked By CU
Drawing No. CU501
Sheet 3 of 4






PUMP STATION VALVE PIT
SCALE: NTS




- NOTES:
1. PRECAST OR POURED IN PLACE VALVE, METER & BYPASS CHAMBER (SUBMIT SHOP DRAWING FOR REVIEW).
 2. ALL PIPING THROUGH WALLS AND WITHIN CHAMBER TO BE DUCTILE IRON PIPE AND FITTINGS.
 3. CONTRACTOR SHALL SUPPLY FLANGED SPOOL PIECE TO REPLACE WATER METER WHEN REMOVED FOR SERVICE.
 4. CHECK SITE PLAN FOR CORRECT ORIENTATION OF PIPING.
 5. BY-PASS CHAMBER TO BE INSTALLED TO H-20 LOADING STANDARDS.

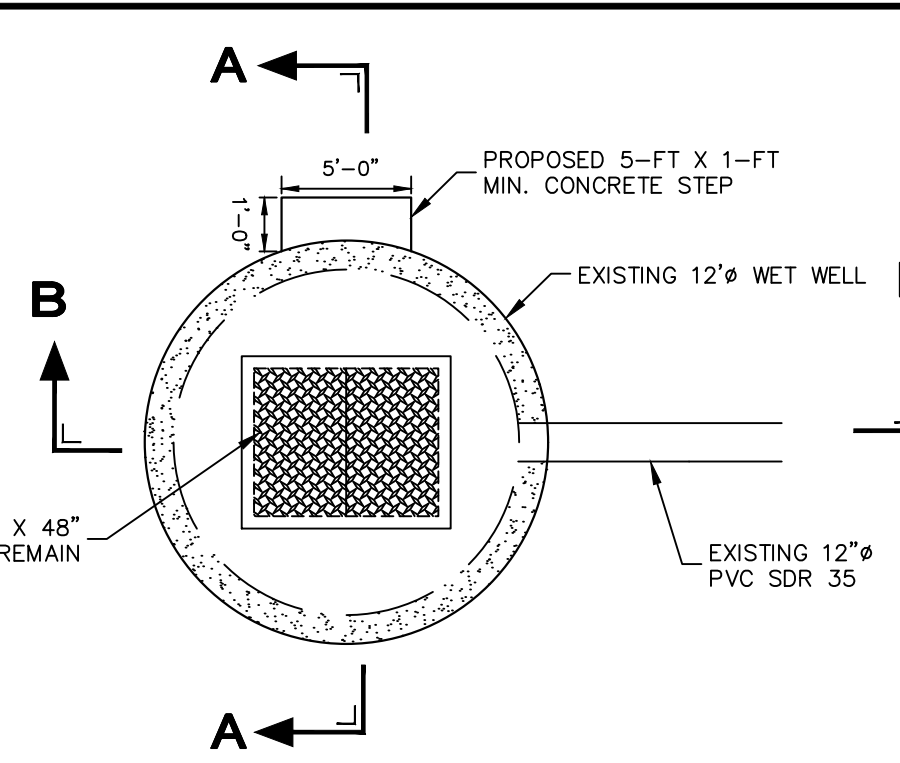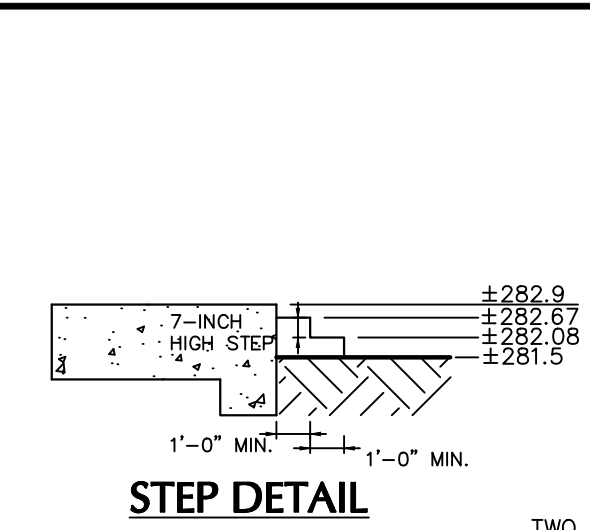

- PUMP INSTALLATION AND 12"-DIAMETER WET WELL MODIFICATION NOTES:
- TEMPORARY PLUG EQUALIZING PIPE AND PUMP OUT STRUCTURE.
 - REMOVE 4" CONCRETE BASE AND SAND IN WET WELL.
 - CORE DRILL NEW PENETRATIONS FOR:
 1. TWO (2) 6" SCH. 80 PVC FORCEMAIN DISCHARGES.
 2. ELECTRICAL CONDUITS.
 3. DRAIN LINE FROM VALVE PIT.
 - INSTALL PUMPS SUPPLIED BY THE BWP/CA, AND RAILS.
 - FORM CONCRETE BASE SLOPE TO CENTER.
 - INSTALL STILLING WELL WITH TRANSDUCER PROVIDED BY BWP/CA.
 - INSTALL FLOATS.
 - INSTALL PIPE SUPPORTS AND HANGERS.
- PUMP REMOVAL AND 7"-DIAMETER WET WELL MODIFICATION NOTES:
- COORDINATE WITH BWP/CA TO TEMPORARILY BYPASS FLOW AROUND STRUCTURE.
 - PUMP OUT STRUCTURE.
 - REMOVE PUMPS, FLOATS, TRANSDUCER, RAILS, PIPE SUPPORTS, HANGERS.
 - PARGE OLD PENETRATIONS FOR:
 1. TWO (2) 6" FORCEMAIN DISCHARGES.
 2. ELECTRICAL CONDUITS.
 3. ABANDONED VENT.
 4. ANY OTHER PENETRATION NO LONGER IN USE.
 - FORM CONCRETE BENCH.

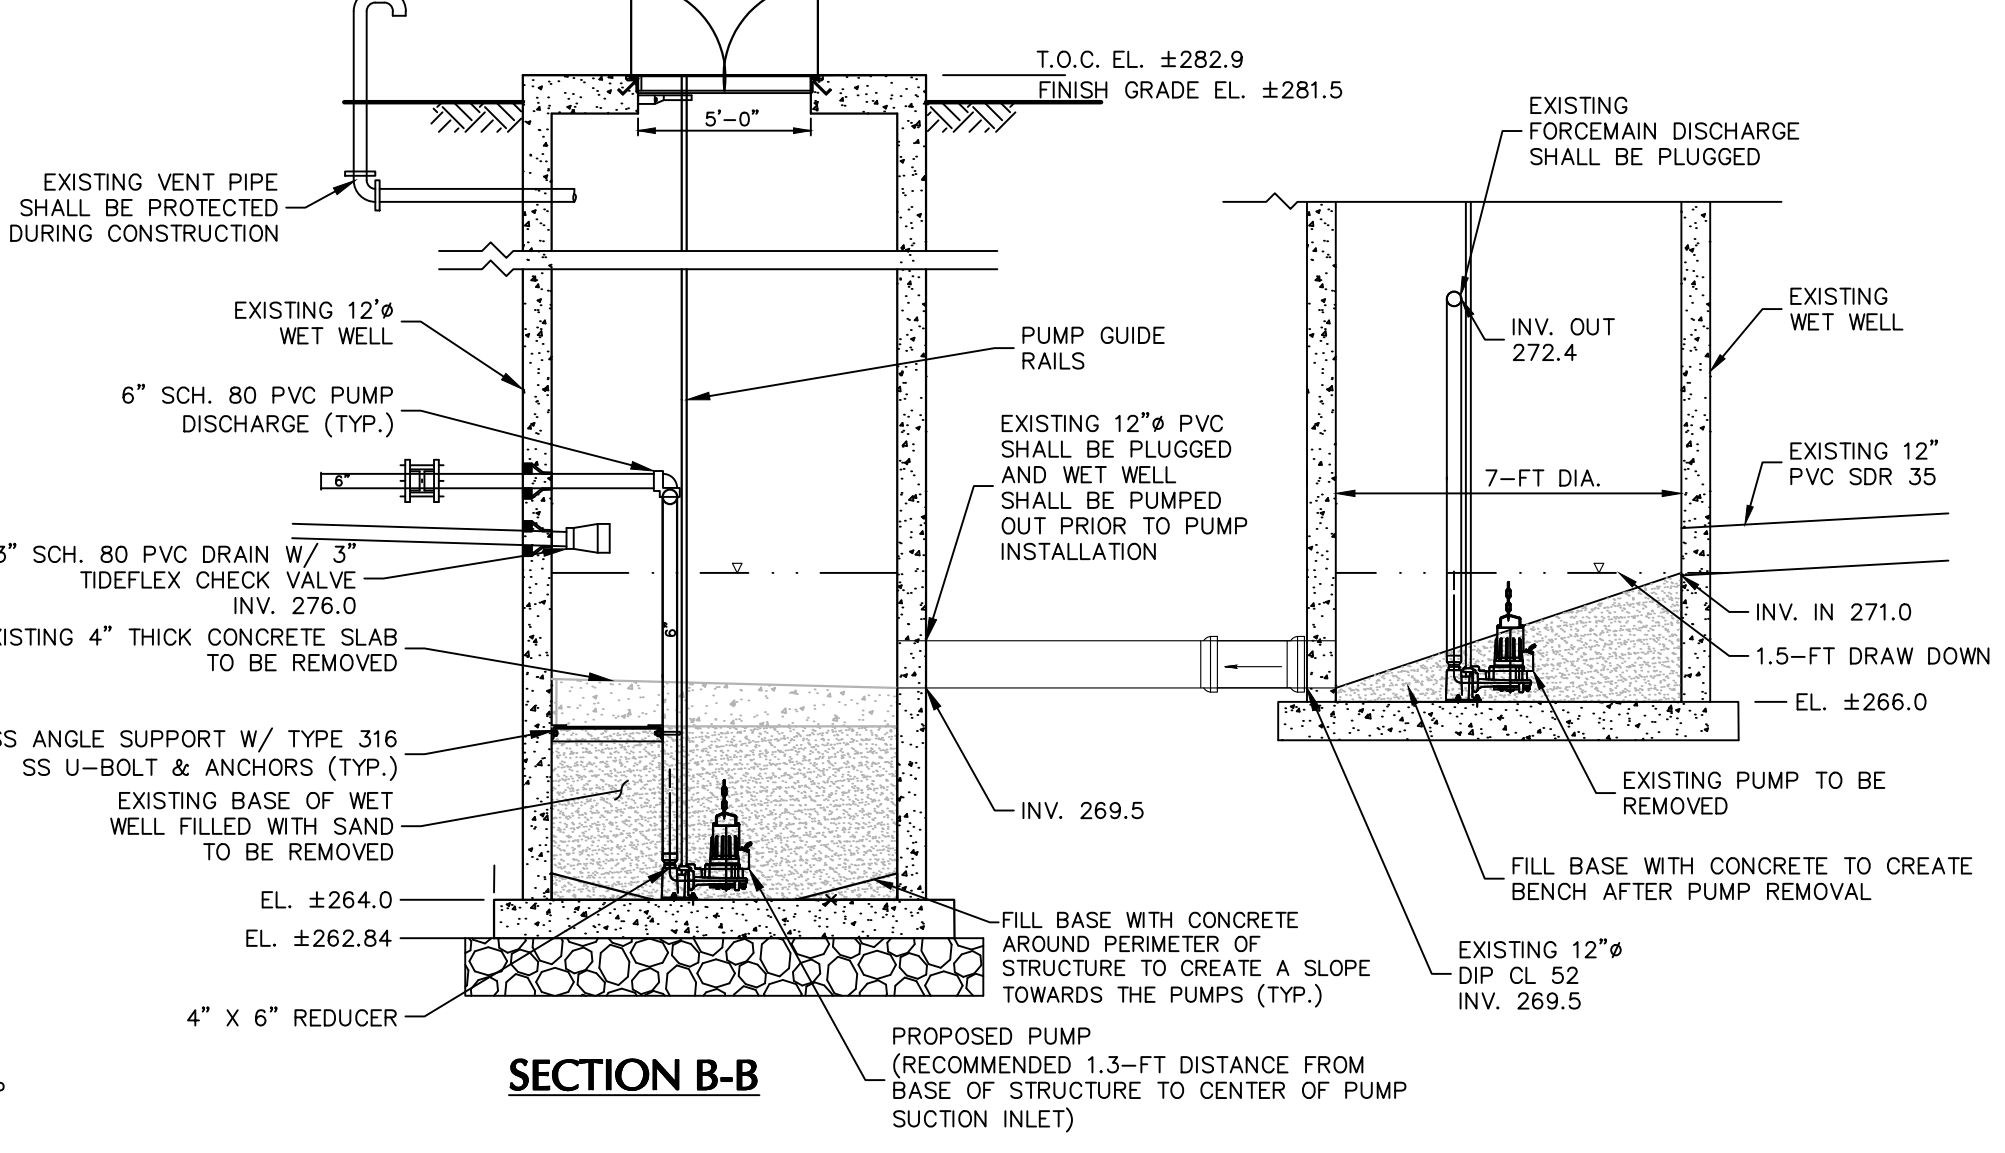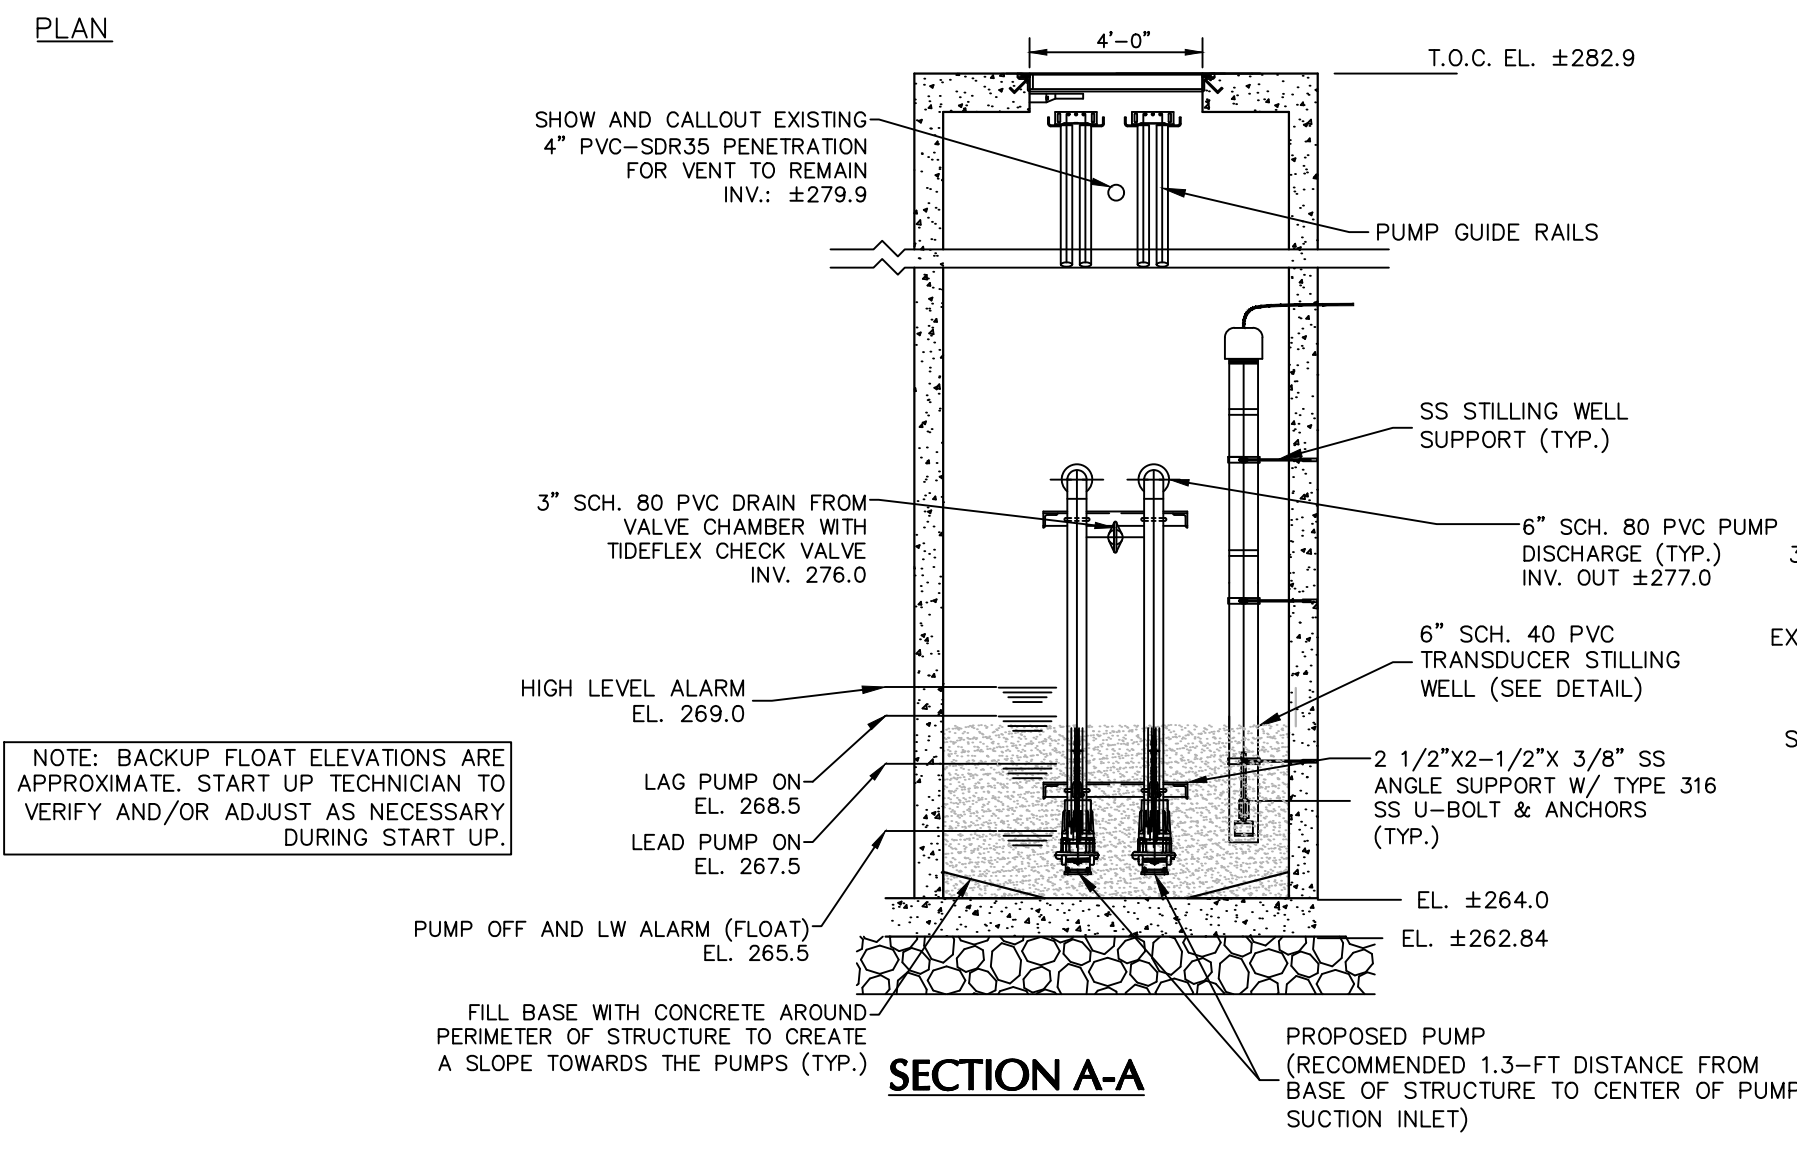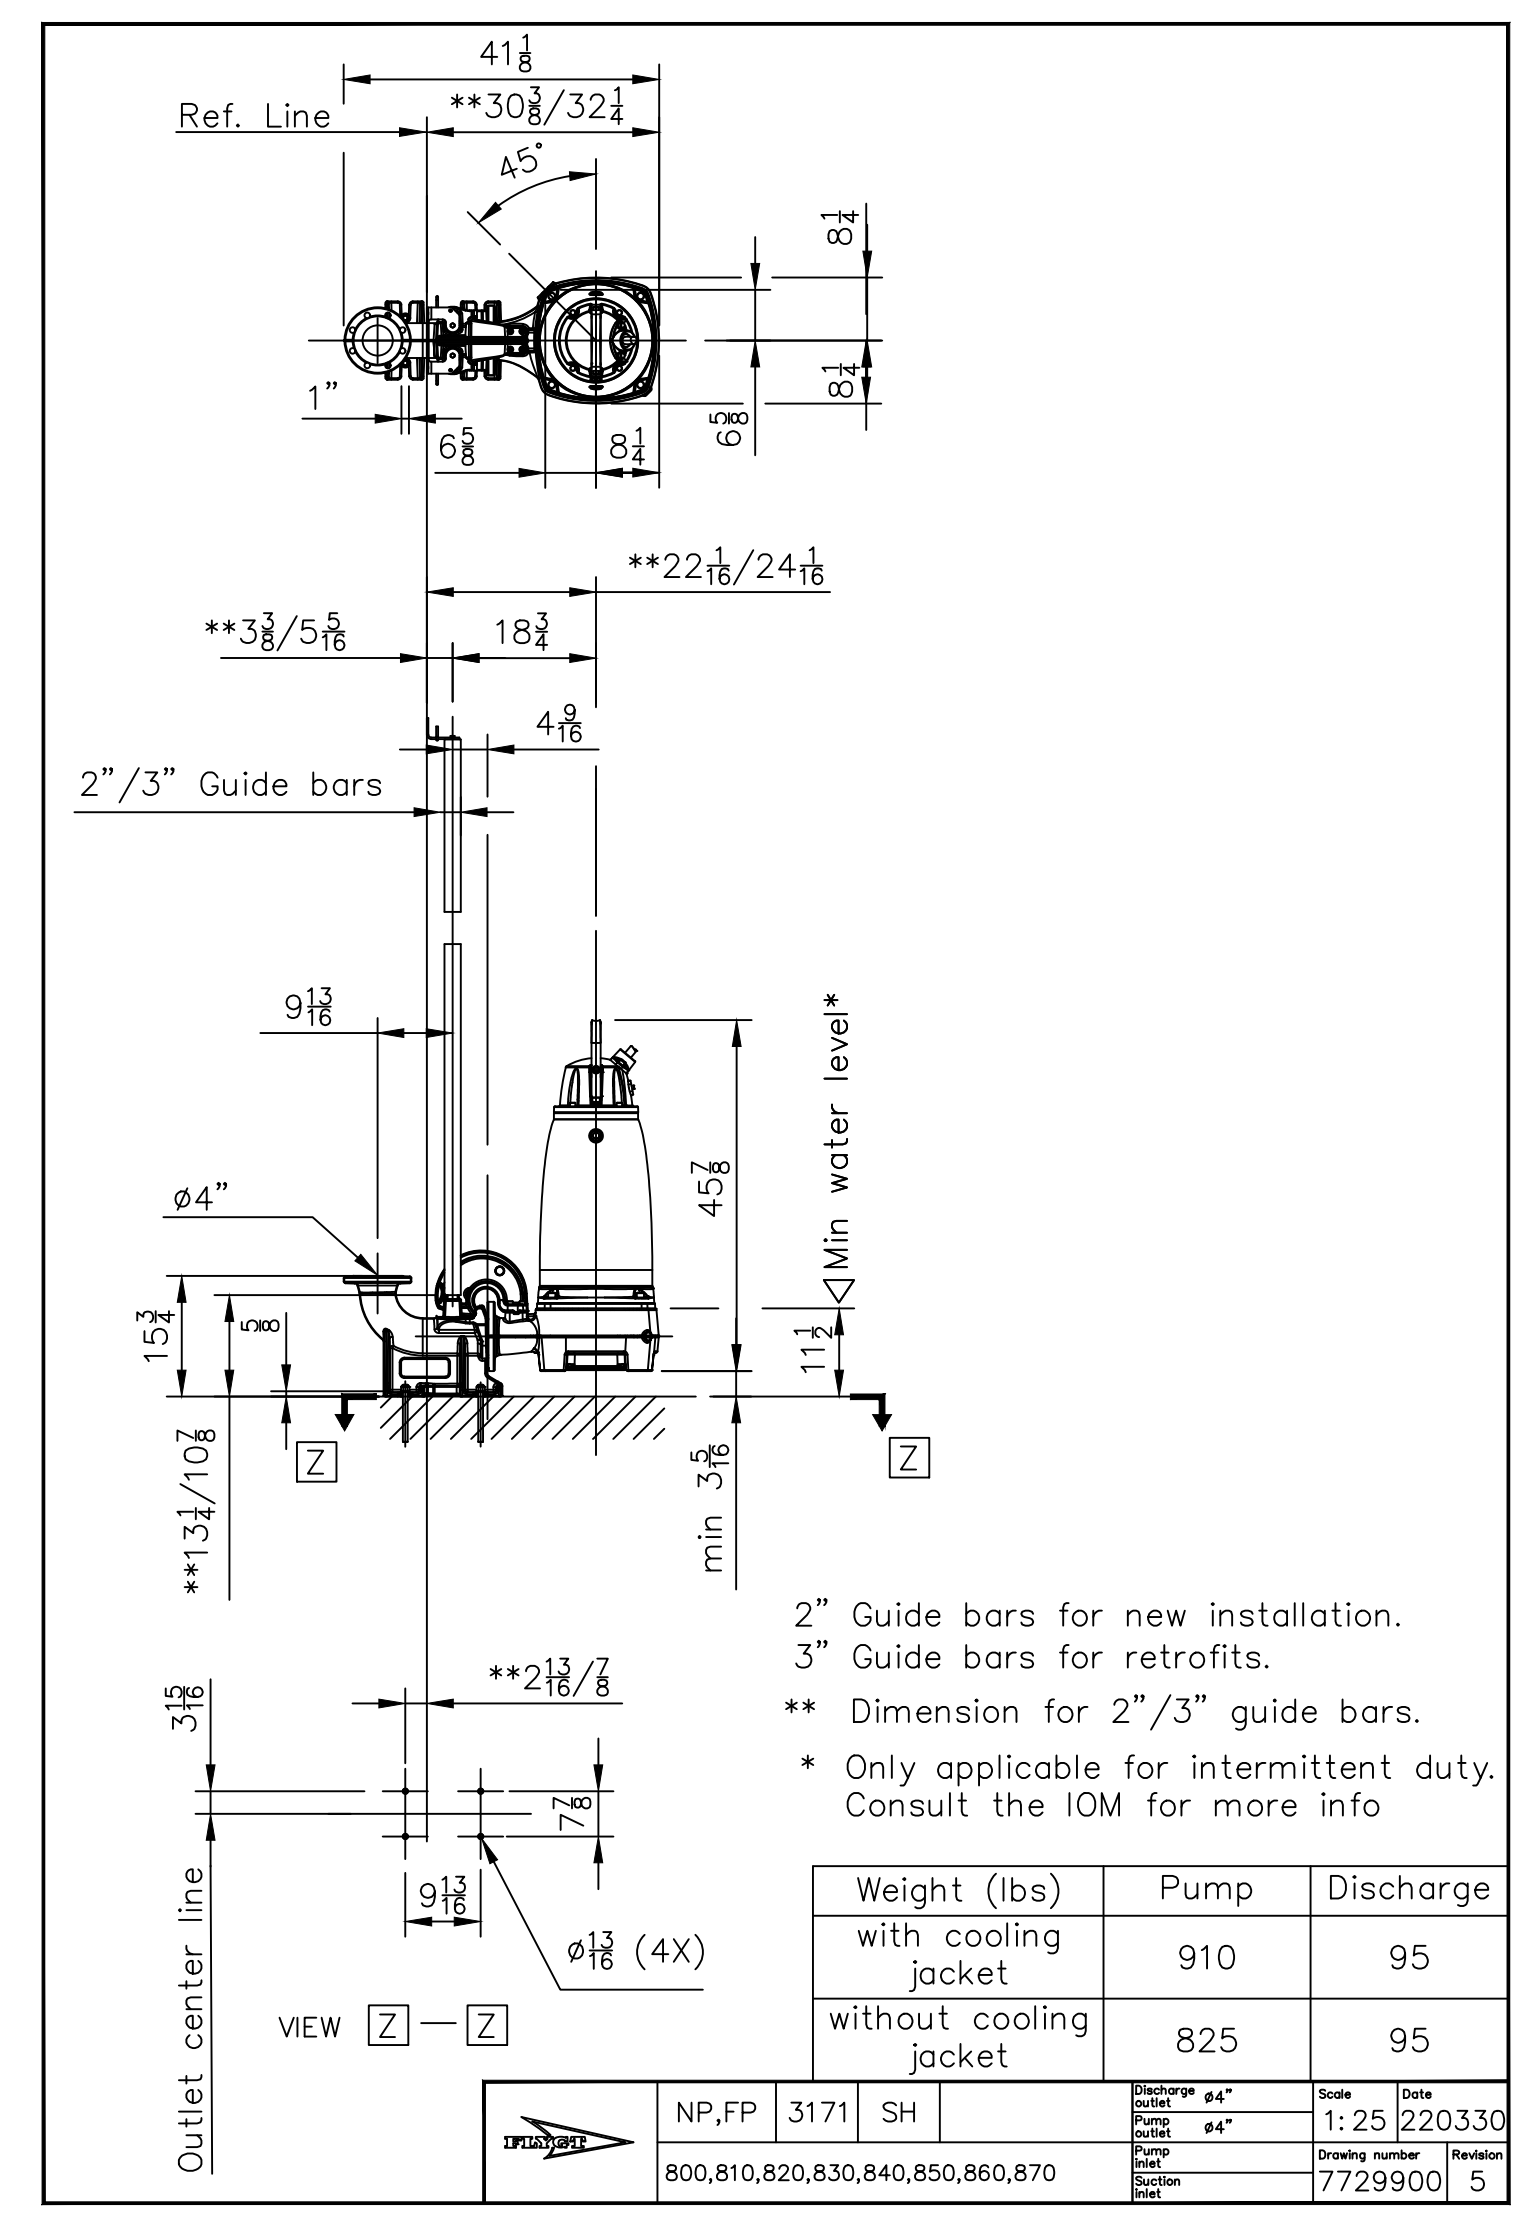

12' WET WELL RETROFIT DETAIL
SCALE: NTS

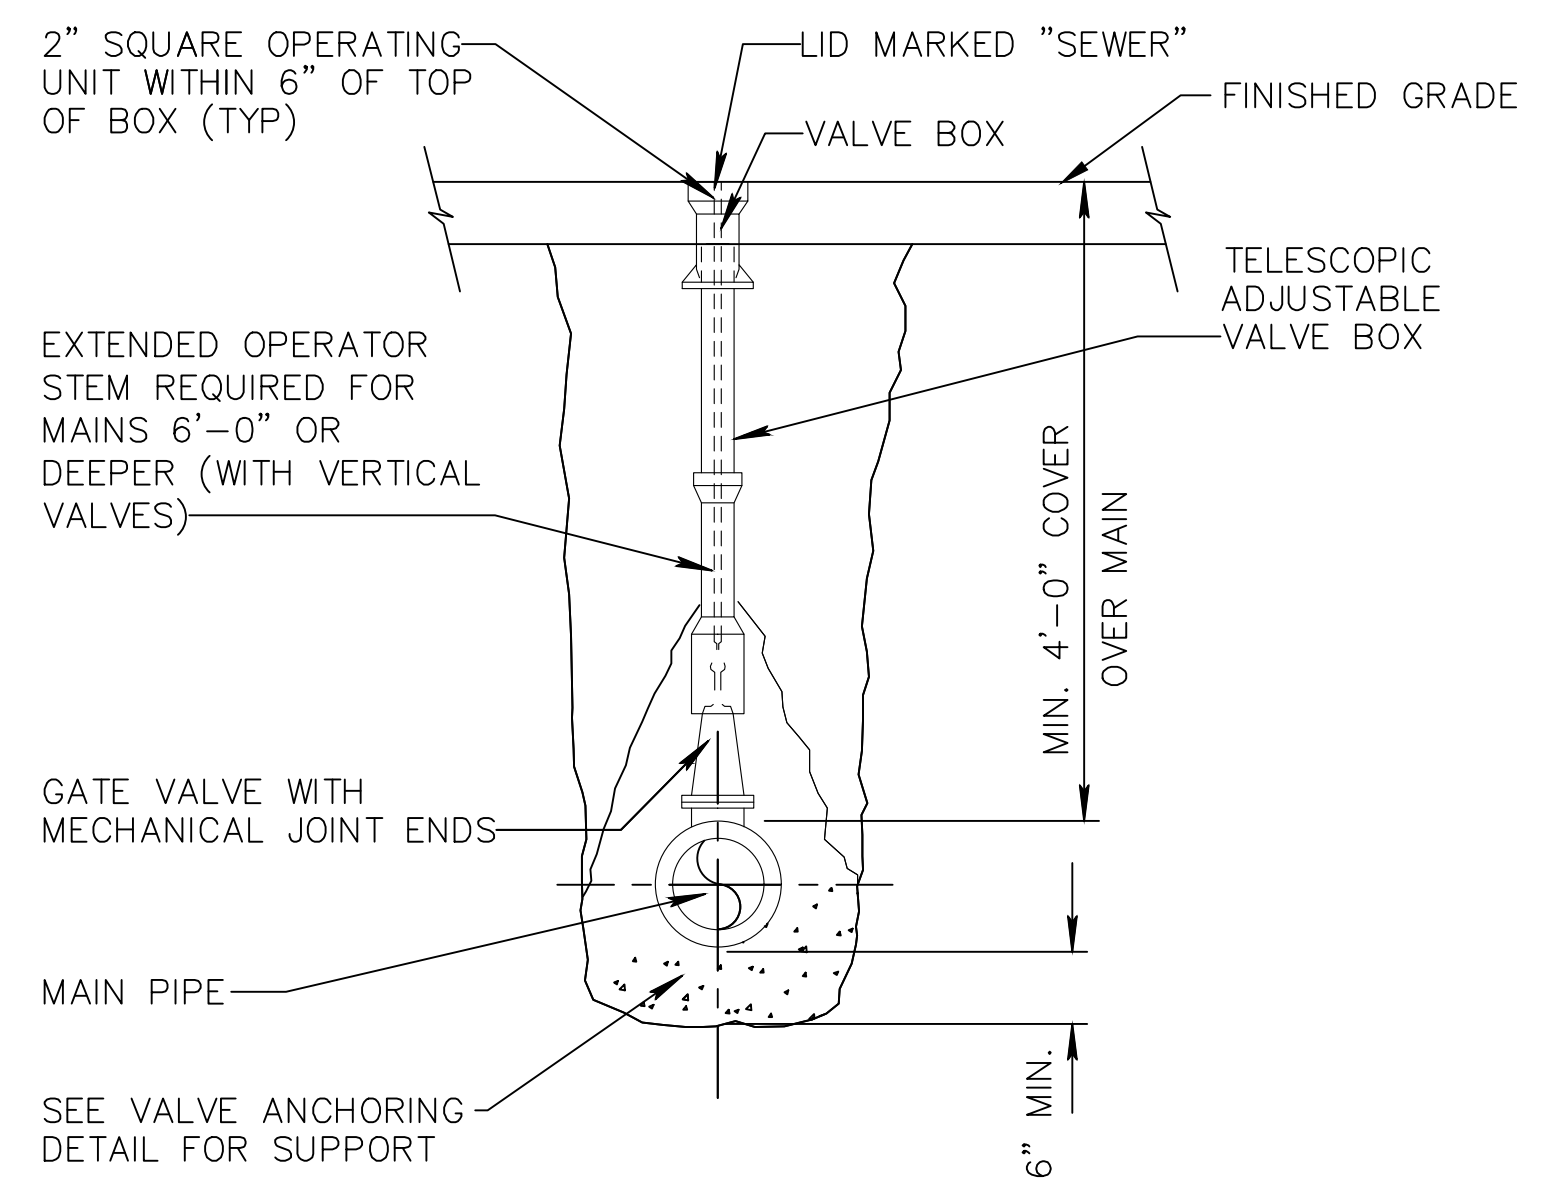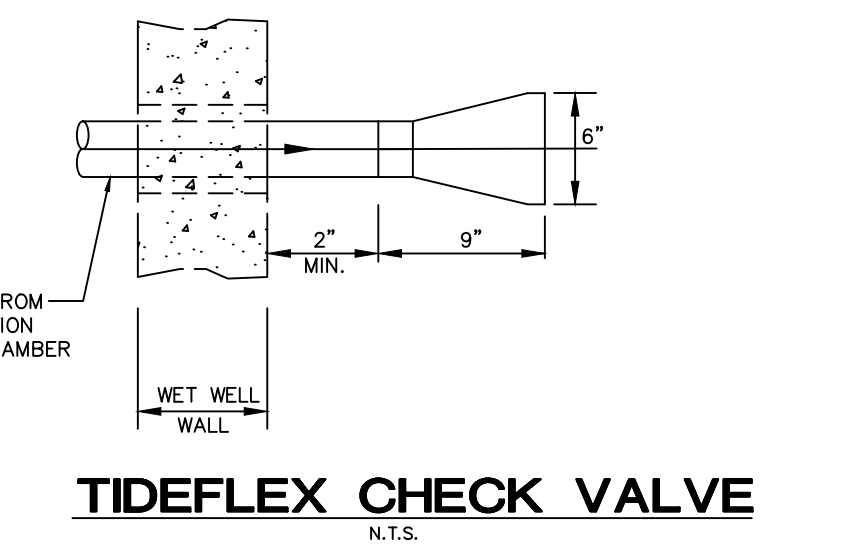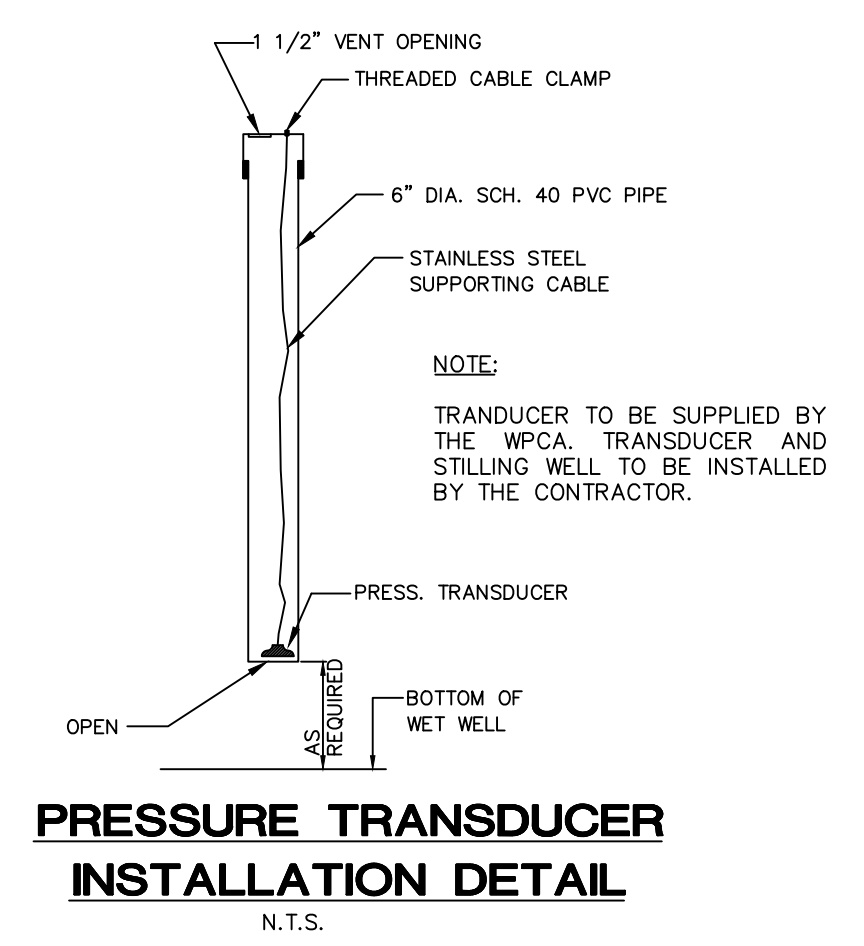

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Revisions		


STATE OF CONNECTICUT
PROFESSIONAL ENGINEER
UTSCHIG JR., P.E.
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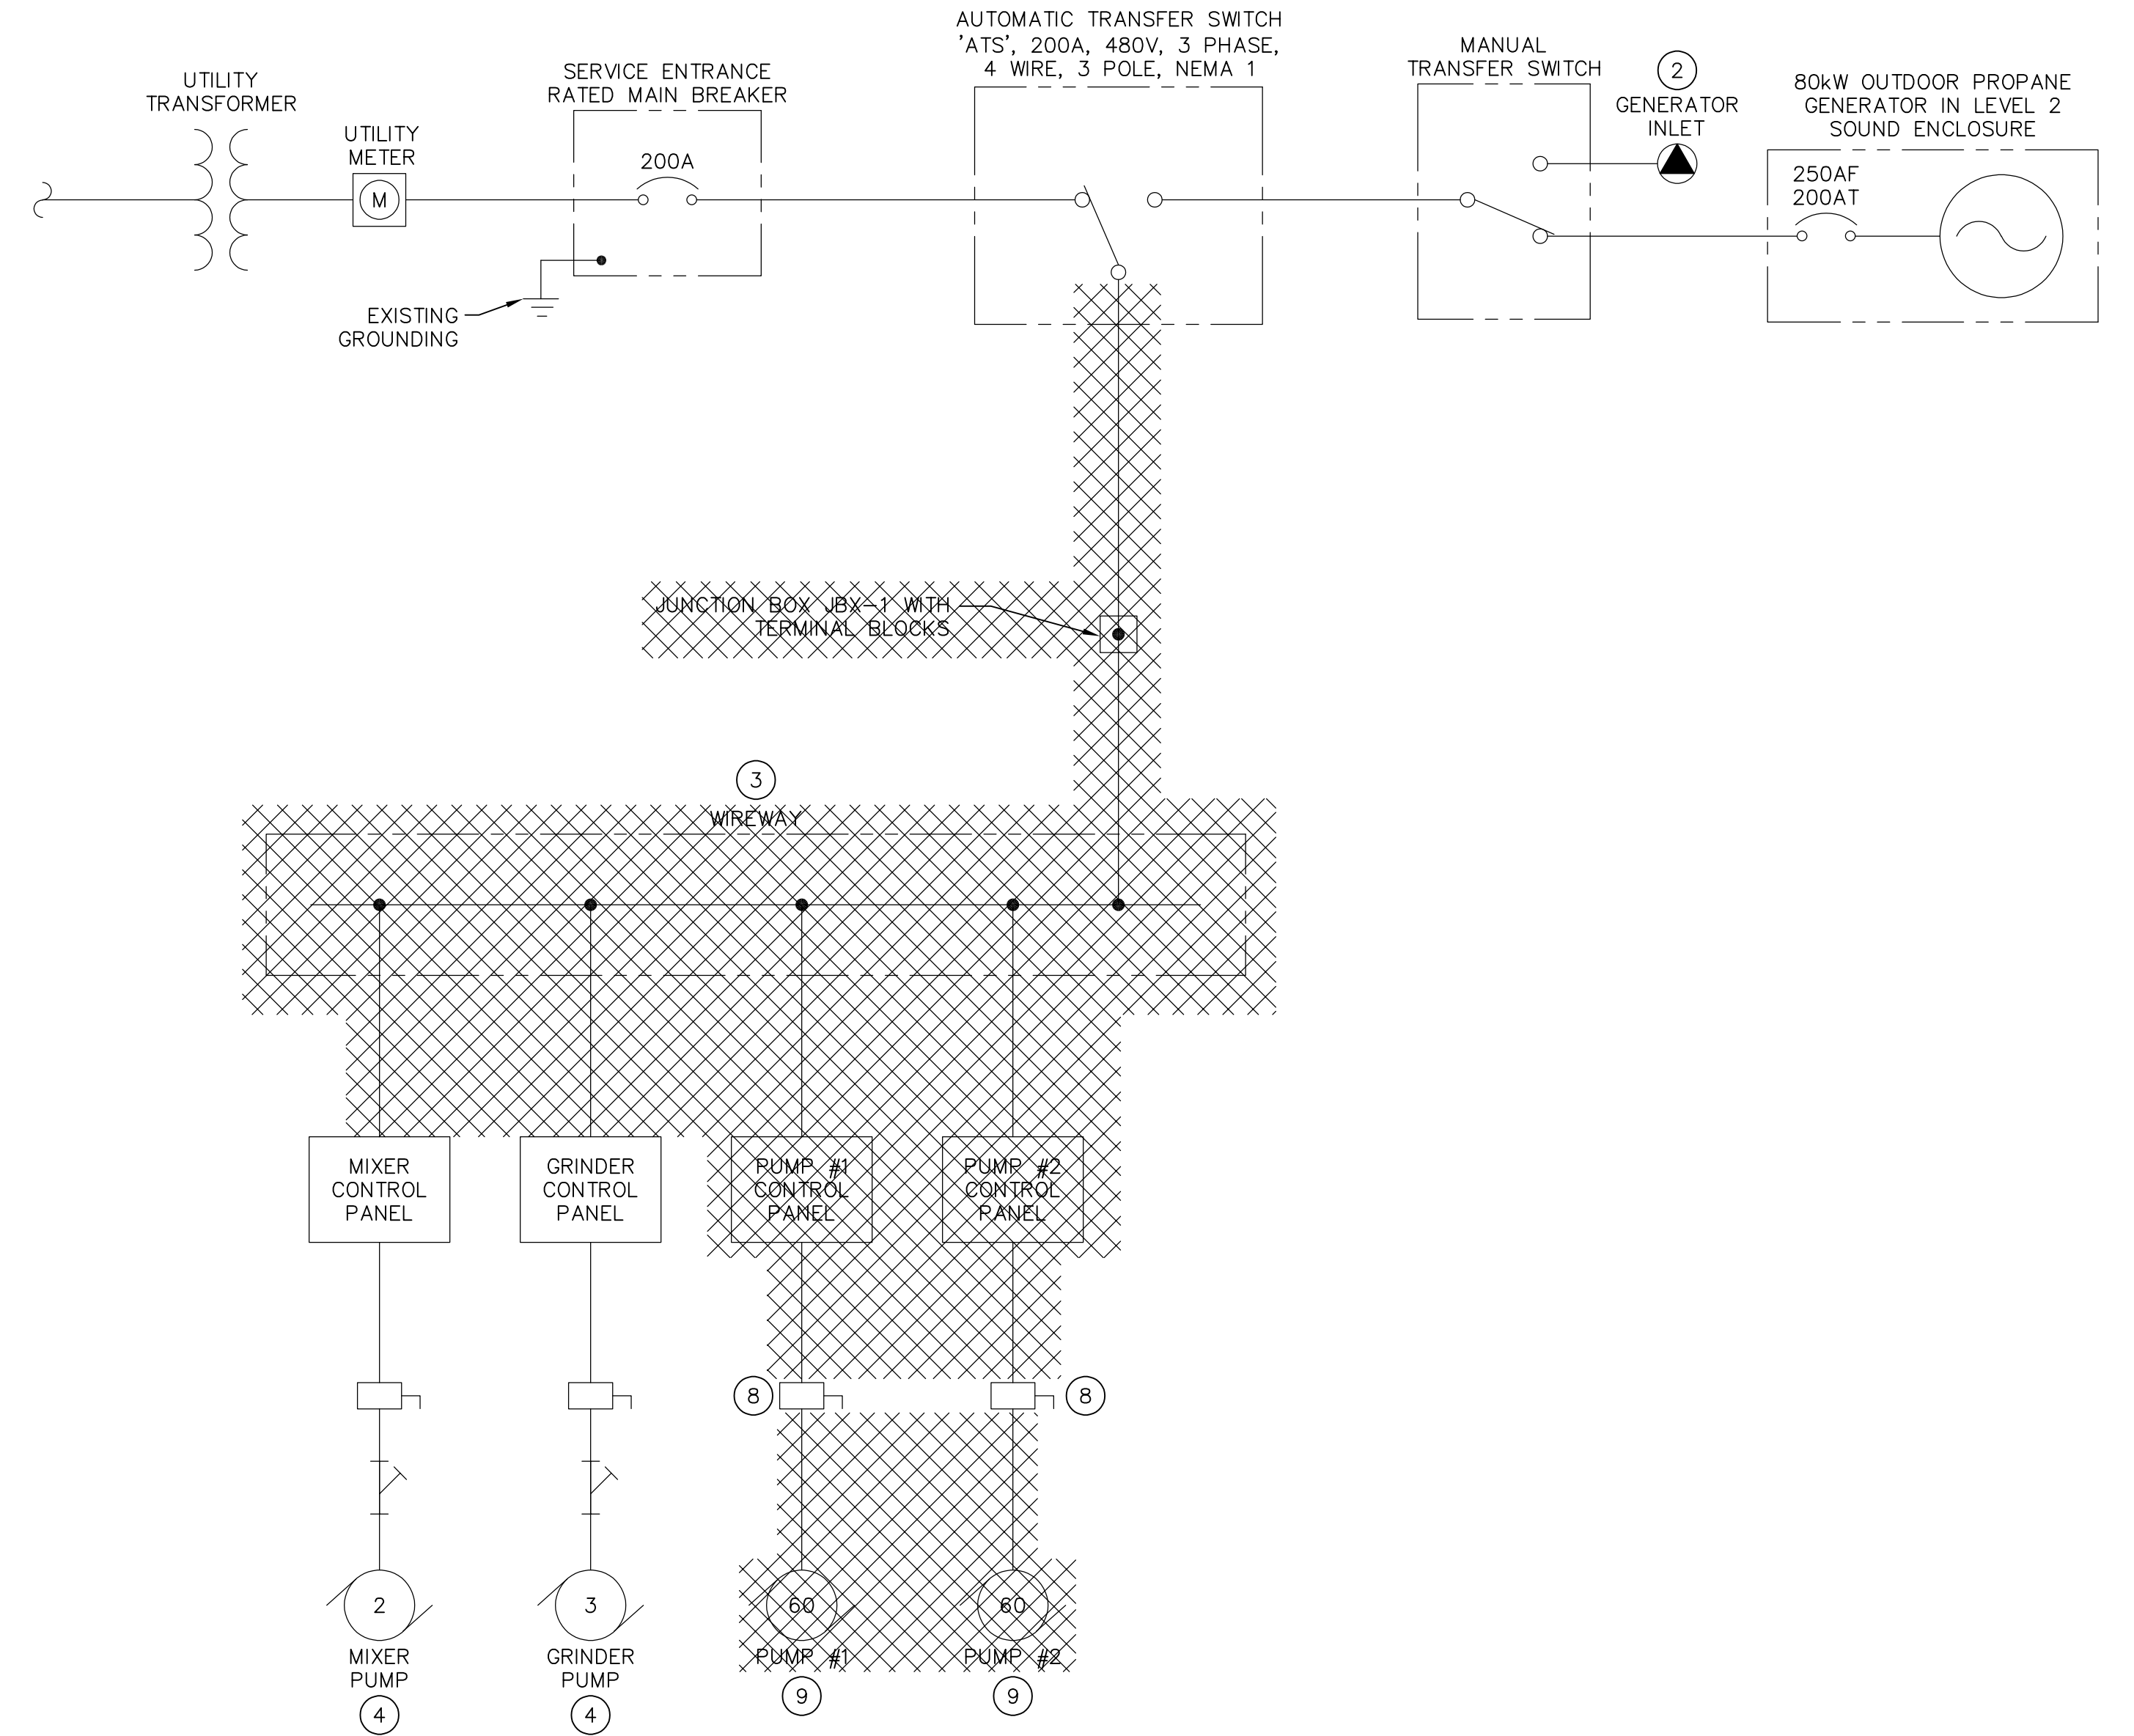
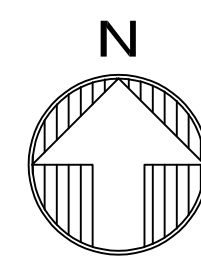
Project
PHASE II - 133 PUMP STATION
BROOKFIELD CONNECTICUT

Drawing Title
CONSTRUCTION DETAILS (2 OF 2)

Project No. 190093201
Date MARCH 8, 2024
Drawn By LM
Checked By CU
Drawing No. CU502
Sheet 4 of 4



ELECTRICAL DEMOLITION PLAN
 1"=1'-0" 0 1 2 3
 SCALE IN FEET

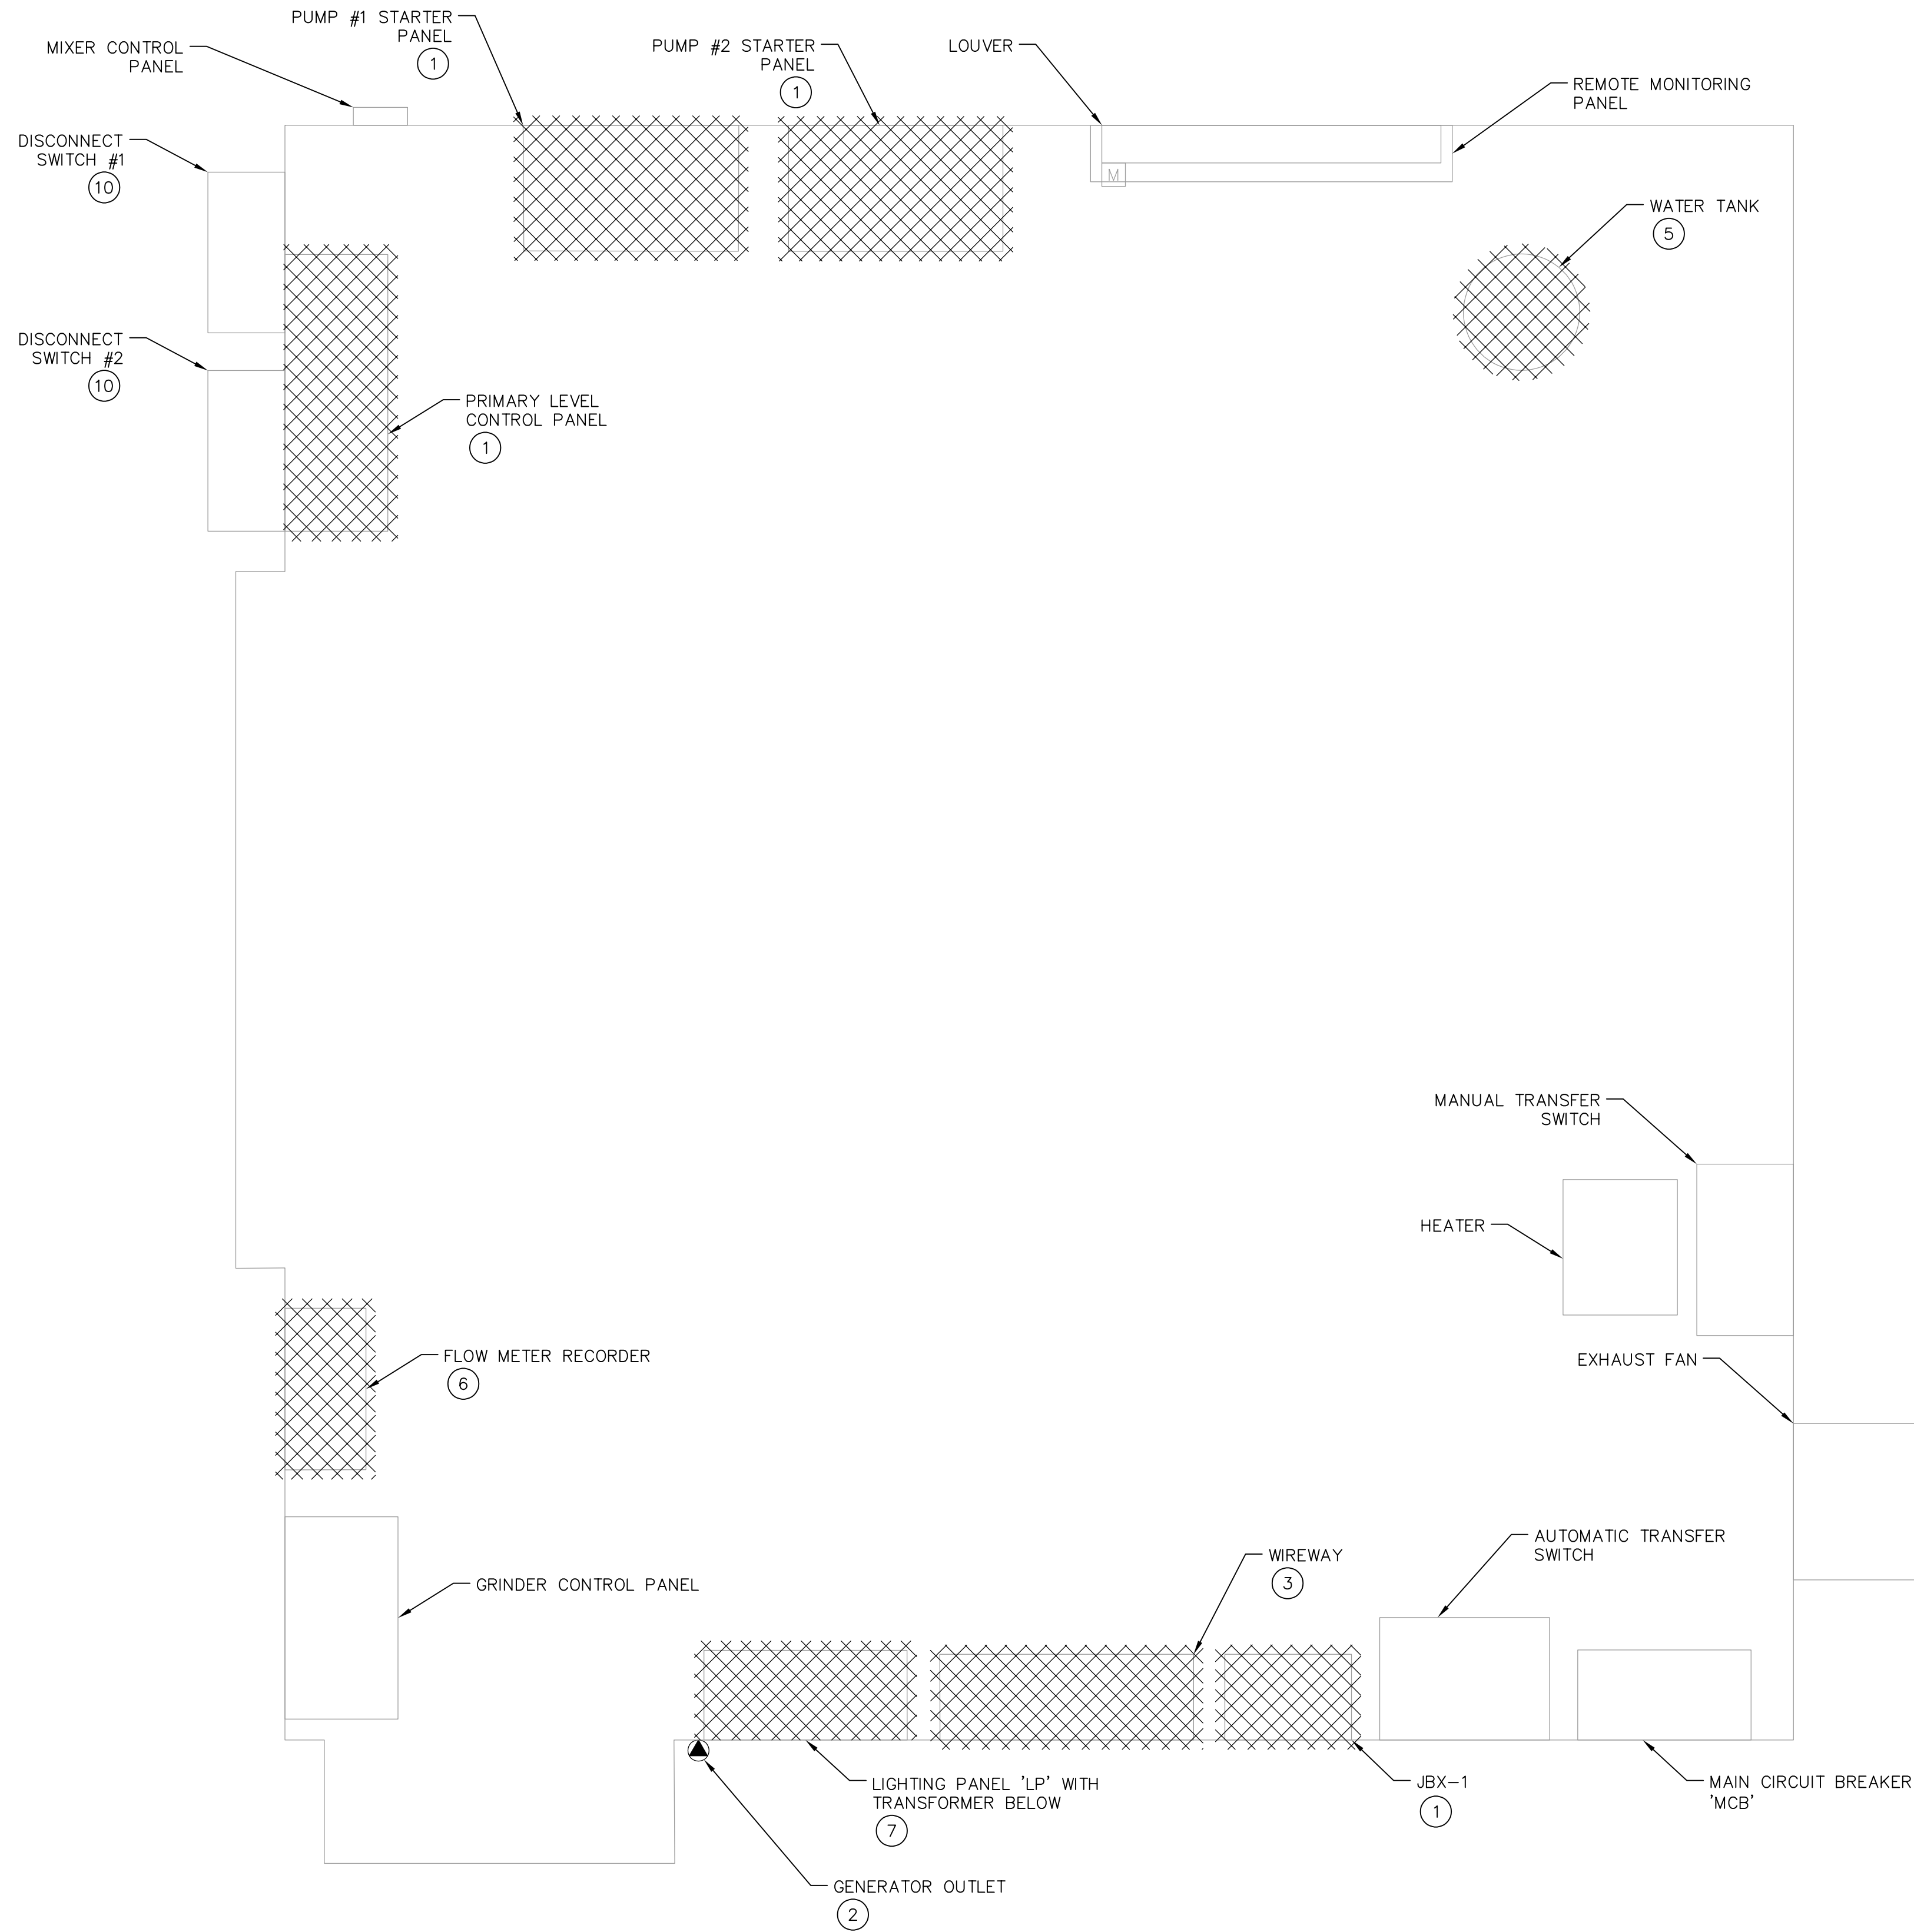


DEMOLITION SINGLE LINE

DEMOLITION NOTES:

- CONTRACTOR SHALL BE RESPONSIBLE FOR THE REMOVAL OF THE EXISTING POWER DISTRIBUTION WIREWAY, TRANSFORMER, JUNCTION BOX, LIGHTING PANELBOARD, PRIMARY LEVEL CONTROL PANEL, AND PUMP STARTER PANELS. CONTRACTOR MUST MAINTAIN EXISTING PUMP CAPACITY THROUGHOUT DURATION OF CONSTRUCTION. SEQUENCE OF CONSTRUCTION TO KEEP PUMPS OPERABLE THROUGHOUT.
- CONTRACTOR SHALL RELOCATE THE EXISTING GENERATOR RECEPTACLE AS INDICATED ON DRAWINGS ED-101 AND E-101.
- CONTRACTOR SHALL DEMOLISH THE EXISTING WIREWAY DISTRIBUTION SYSTEM ONCE NEW ELECTRICAL DISTRIBUTION SYSTEM HAS BEEN INSTALLED TO MINIMIZE OUTAGES TO THE PUMP STATION. ALL OUTAGES MUST BE COORDINATED WITH THE OWNER.
- EXISTING EQUIPMENT TO REMAIN FOR RE-CONNECTION.
- EXISTING WATER TANK SHALL BE REMOVED. REFERENCE PROCESS PLANS FOR DETAILS.
- CONTRACTOR SHALL DEMOLISH EXISTING FLOW METER RECORDER AND CLEAR WALLSPACE FOR INSTALLATION OF NEW FLOW METER RECORDER.
- CONTRACTOR SHALL BE RESPONSIBLE TO TEMPORARILY POWER THE TRANSFORMER AND LIGHTING PANEL FROM THE PROPOSED POWER PANELBOARD TO SUPPLY 120/240V LOADS. CONTRACTOR SHALL DEMOLISH TRANSFORMER AND LIGHTING PANELBOARD ONCE PROPOSED TRANSFORMER AND PANELBOARD HAVE BEEN INSTALLED, AFTER SUCCESSFUL STARTUP OF SUBMERSIBLE PUMPS #1 AND #2.
- CONTRACTOR SHALL RETAIN EXISTING NON-FUSED, 100 AMP, 480V, 3 POLE, NEMA 4X SS DISCONNECT SWITCHES FOR RE-USE.
- CONTRACTOR SHALL BE RESPONSIBLE TO PROVIDE TEMPORARY POWER TO EXISTING PUMPS THROUGHOUT DURATION OF CONSTRUCTION. EXISTING PUMPS SHALL BE DEMOLISHED ONLY AFTER NEW SYSTEM IS ONLINE.
- CONTRACTOR SHALL BE RESPONSIBLE FOR MAINTAINING EXISTING 100 AMP DISCONNECT SWITCHES IN PLACE FOR RE-USE. CONTRACTOR SHALL PROVIDE TEMPORARY DISCONNECTING MEANS FOR EXISTING PUMPS THROUGHOUT DURATION OF CONSTRUCTION UNTIL NEW PUMP STATION IS COMMISSIONED.

8/28/24	ISSUED FOR REBID	01
Date	Description	No.
Revisions		

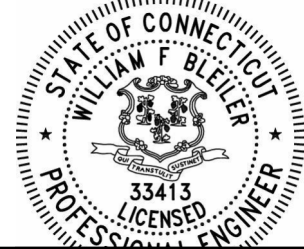
 SIGNATURE: WILLIAM F. BLEILER, P.E.
 DATE SIGNED: 8/28/24
 PROFESSIONAL ENGINEER CT LIC. NO. 33413


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Project
PHASE II - 133 PUMP STATION
 FAIRFIELD COUNTY BROOKFIELD CONNECTICUT


Drawing Title
ELECTRICAL DEMOLITION PLAN AND SINGLE LINE

Project No.
 190093201
 Date
 8/28/2024
 Drawn By
 TOS
 Checked By
 HRS

ED-101
 Sheet 1 of 7

POWER SYMBOLS


RECEPTACLES MOUNTED 36" AFF UNLESS OTHERWISE NOTED

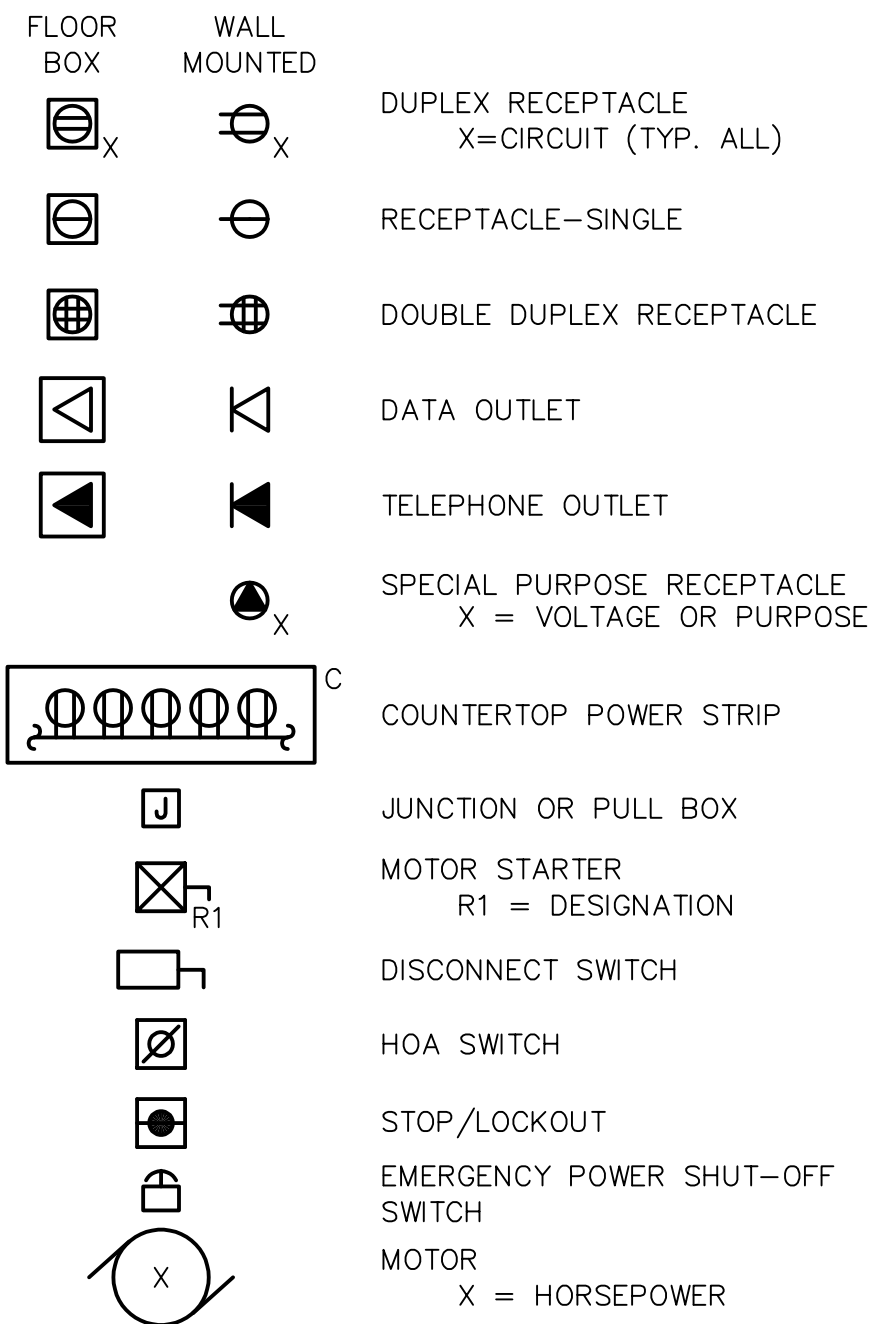


ABBREVIATIONS

- 3P 3 POLE
- 4X NEMA 4X
- A AMP
- AC ALTERNATING CURRENT
- AF AMP FRAME
- AFF ABOVE FINISHED FLOOR
- AT AMP TRIP
- ATS AUTOMATIC TRANSFER SWITCH
- AWG AMERICAN WIRE GAUGE
- BLDG BUILDING
- CKT CIRCUIT
- CMD COMMAND
- CP CONTROL PANEL
- DIA DIAMETER
- DIV DIVISION
- DS DISCONNECT SWITCH
- EUH ELECTRIC UNIT HEATER
- EXP EXPLOSION PROOF (NEMA 8)
- FDBK FEEDBACK
- FNVR FULL VOLTAGE NON REVERSING
- GFCI GROUND FAULT CIRCUIT INTERRUPTER
- GND GROUND
- HOA HAND-OFF-AUTOMATIC
- HP HORSE POWER
- HVAC HEAT-VENT-AIR CONDITIONING
- JB JUNCTION BOX
- KA KILOAMPERE
- KCMIL 1000 CIRCULAR MILS
- KV KILOVOLT
- KVA KILOVOLT AMPERE
- KW KILOWATT
- LTG LIGHTING
- MAX MAXIMUM
- MC MANUFACTURER'S CABLE
- MCC MOTOR CONTROL CENTER
- MCP MOTOR CIRCUIT PROTECTOR
- MFR MANUFACTURER
- MIN MINIMUM
- MS MOTOR STARTER
- N/A NOT APPLICABLE
- N.C. NORMALLY CLOSED
- NEMA NATIONAL ELECTRICAL MANUFACTURER'S ASSOCIATION
- N.O. NORMALLY OPEN
- No. NUMBER
- PH PHASE
- OR OR
- PNL PANEL
- PSI POUNDS PER SQUARE INCH
- PVC POLYVINYL CHLORIDE
- QTY QUANTITY
- RGS RIGID GALVANIZED STEEL
- RVSS REDUCED VOLTAGE SOLID STATE
- SP SPARE
- SS STAINLESS STEEL
- STP SHIELDED TWISTED PAIR
- TYP TYPICAL
- TVSS TRANSIENT VOLTAGE SURGE SUPPRESSION
- U.O.N. UNLESS OTHERWISE NOTED
- V VOLT
- VAC VOLTS ALTERNATING CIRCUIT
- VFD VARIABLE FREQUENCY DRIVE
- W WIRE
- WPU WEATHERPROOF IN-USE
- WR WEATHER RESISTANT
- XFMR TRANSFORMER

SCHEMATIC DIAGRAM SYMBOLS

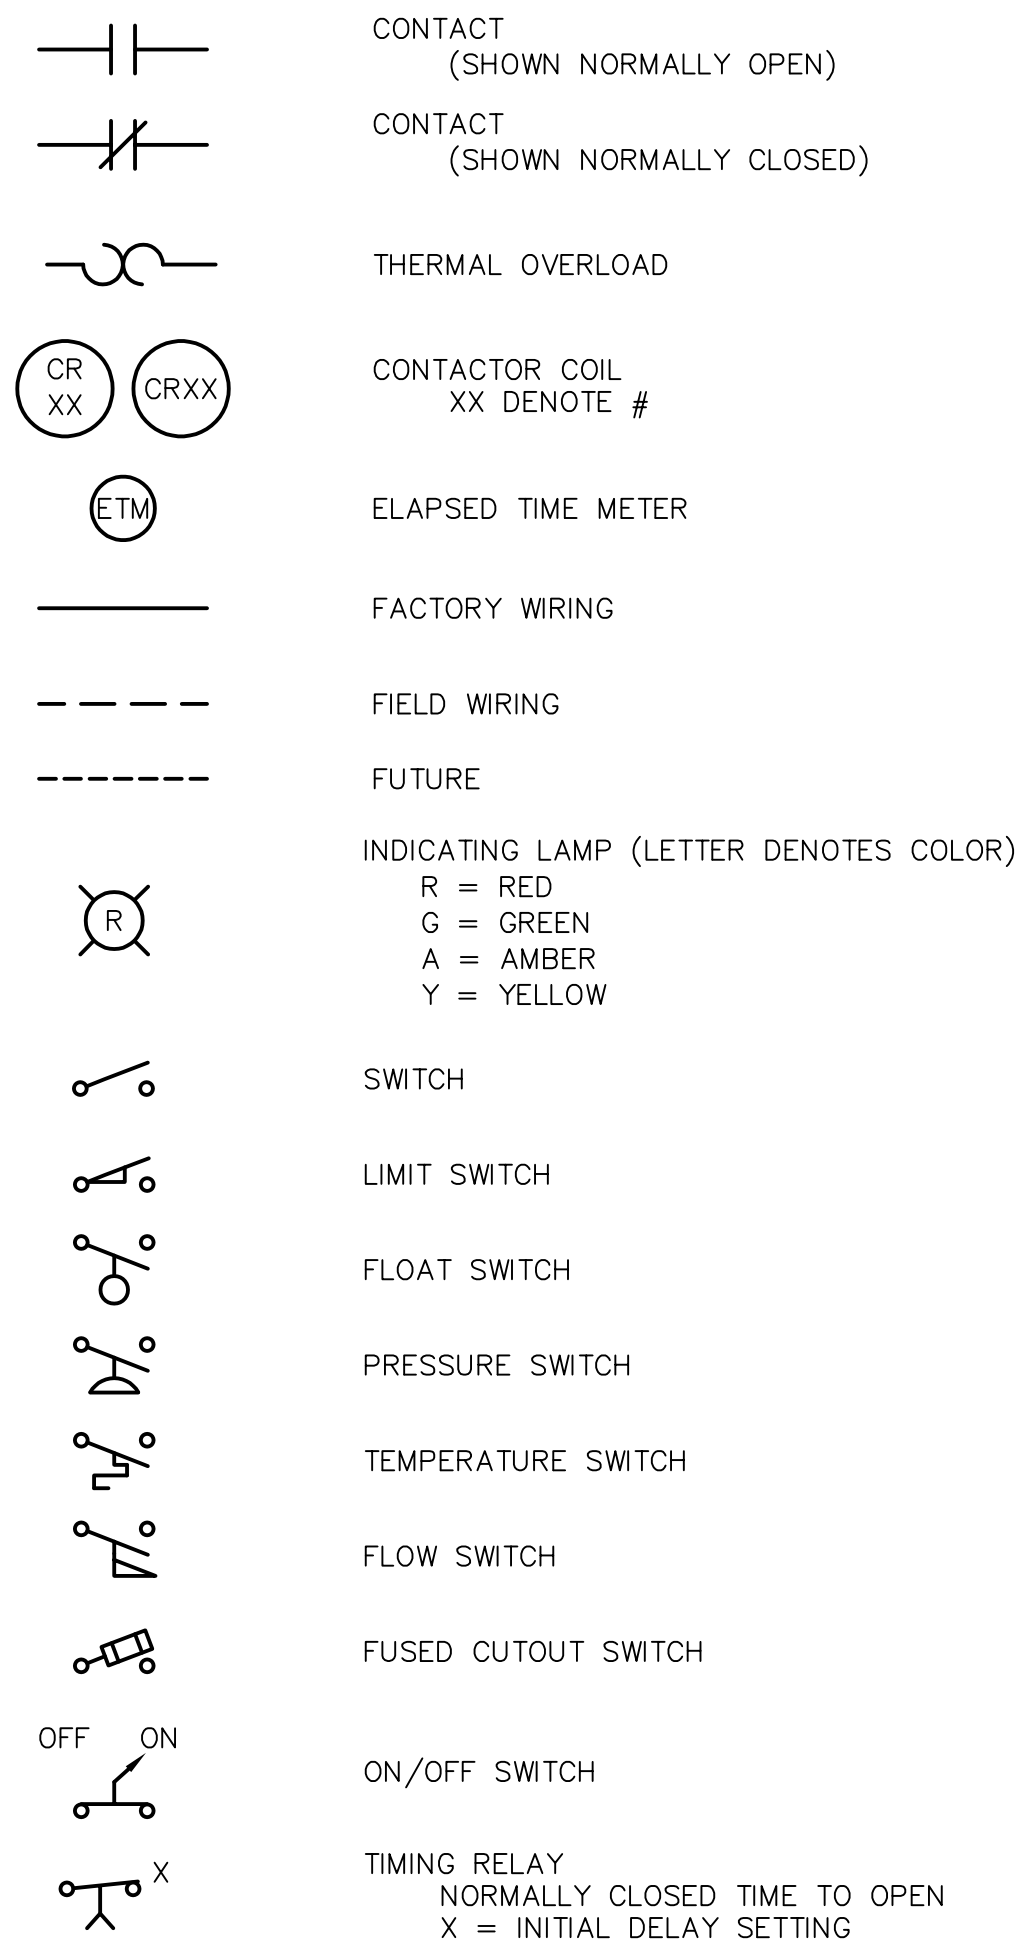


INSTRUMENT SYMBOL DECODER

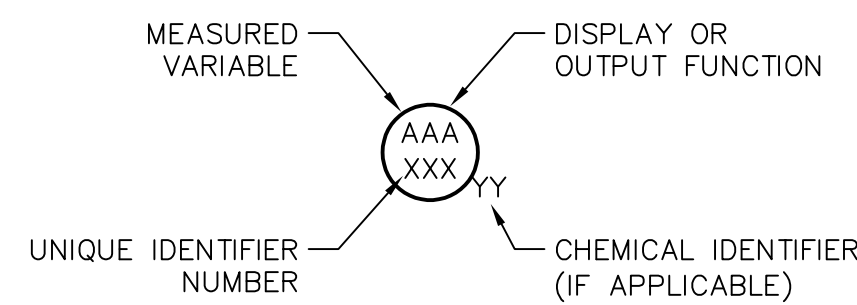

FIRST LETTER 'A'	SUCCEEDING LETTERS 'B'
MEASURED VARIABLE	DISPLAY OR OUTPUT FUNCTION
A ANALYZER	ALARM
B BURNER	-
C -	CONTROL
D DIFFERENTIAL	DIFFERENTIAL
E VOLTAGE	PRIMARY ELEMENT
F FLOW RATE	-
G -	GLASS
H HAND	HIGH
I CURRENT	INDICATE
J POWER	SCAN
K TIME	CONTROL STATION
L LEVEL	LOW/LIGHT
M MALFUNCTION	MIDDLE
N TURBIDITY	-
O -	ORIFICE
P PRESSURE	-
Q QUANTITY	INTEGRATE/TOTALIZE
R REMOTE	RECORD/PRINT
S SPEED/FREQUENCY	SWITCH
T TEMPERATURE	TRANSMIT
U MULTIVARIABLE	MULTIFUNCTION
V VIBRATION	VALVE
W WEIGHT	-
X LIMIT	RELAY
Y STATUS	COMPUTING OR SIGNAL CONVERTING
Z POSITION	DRIVE/ACTUATE


SINGLE LINE SYMBOLS

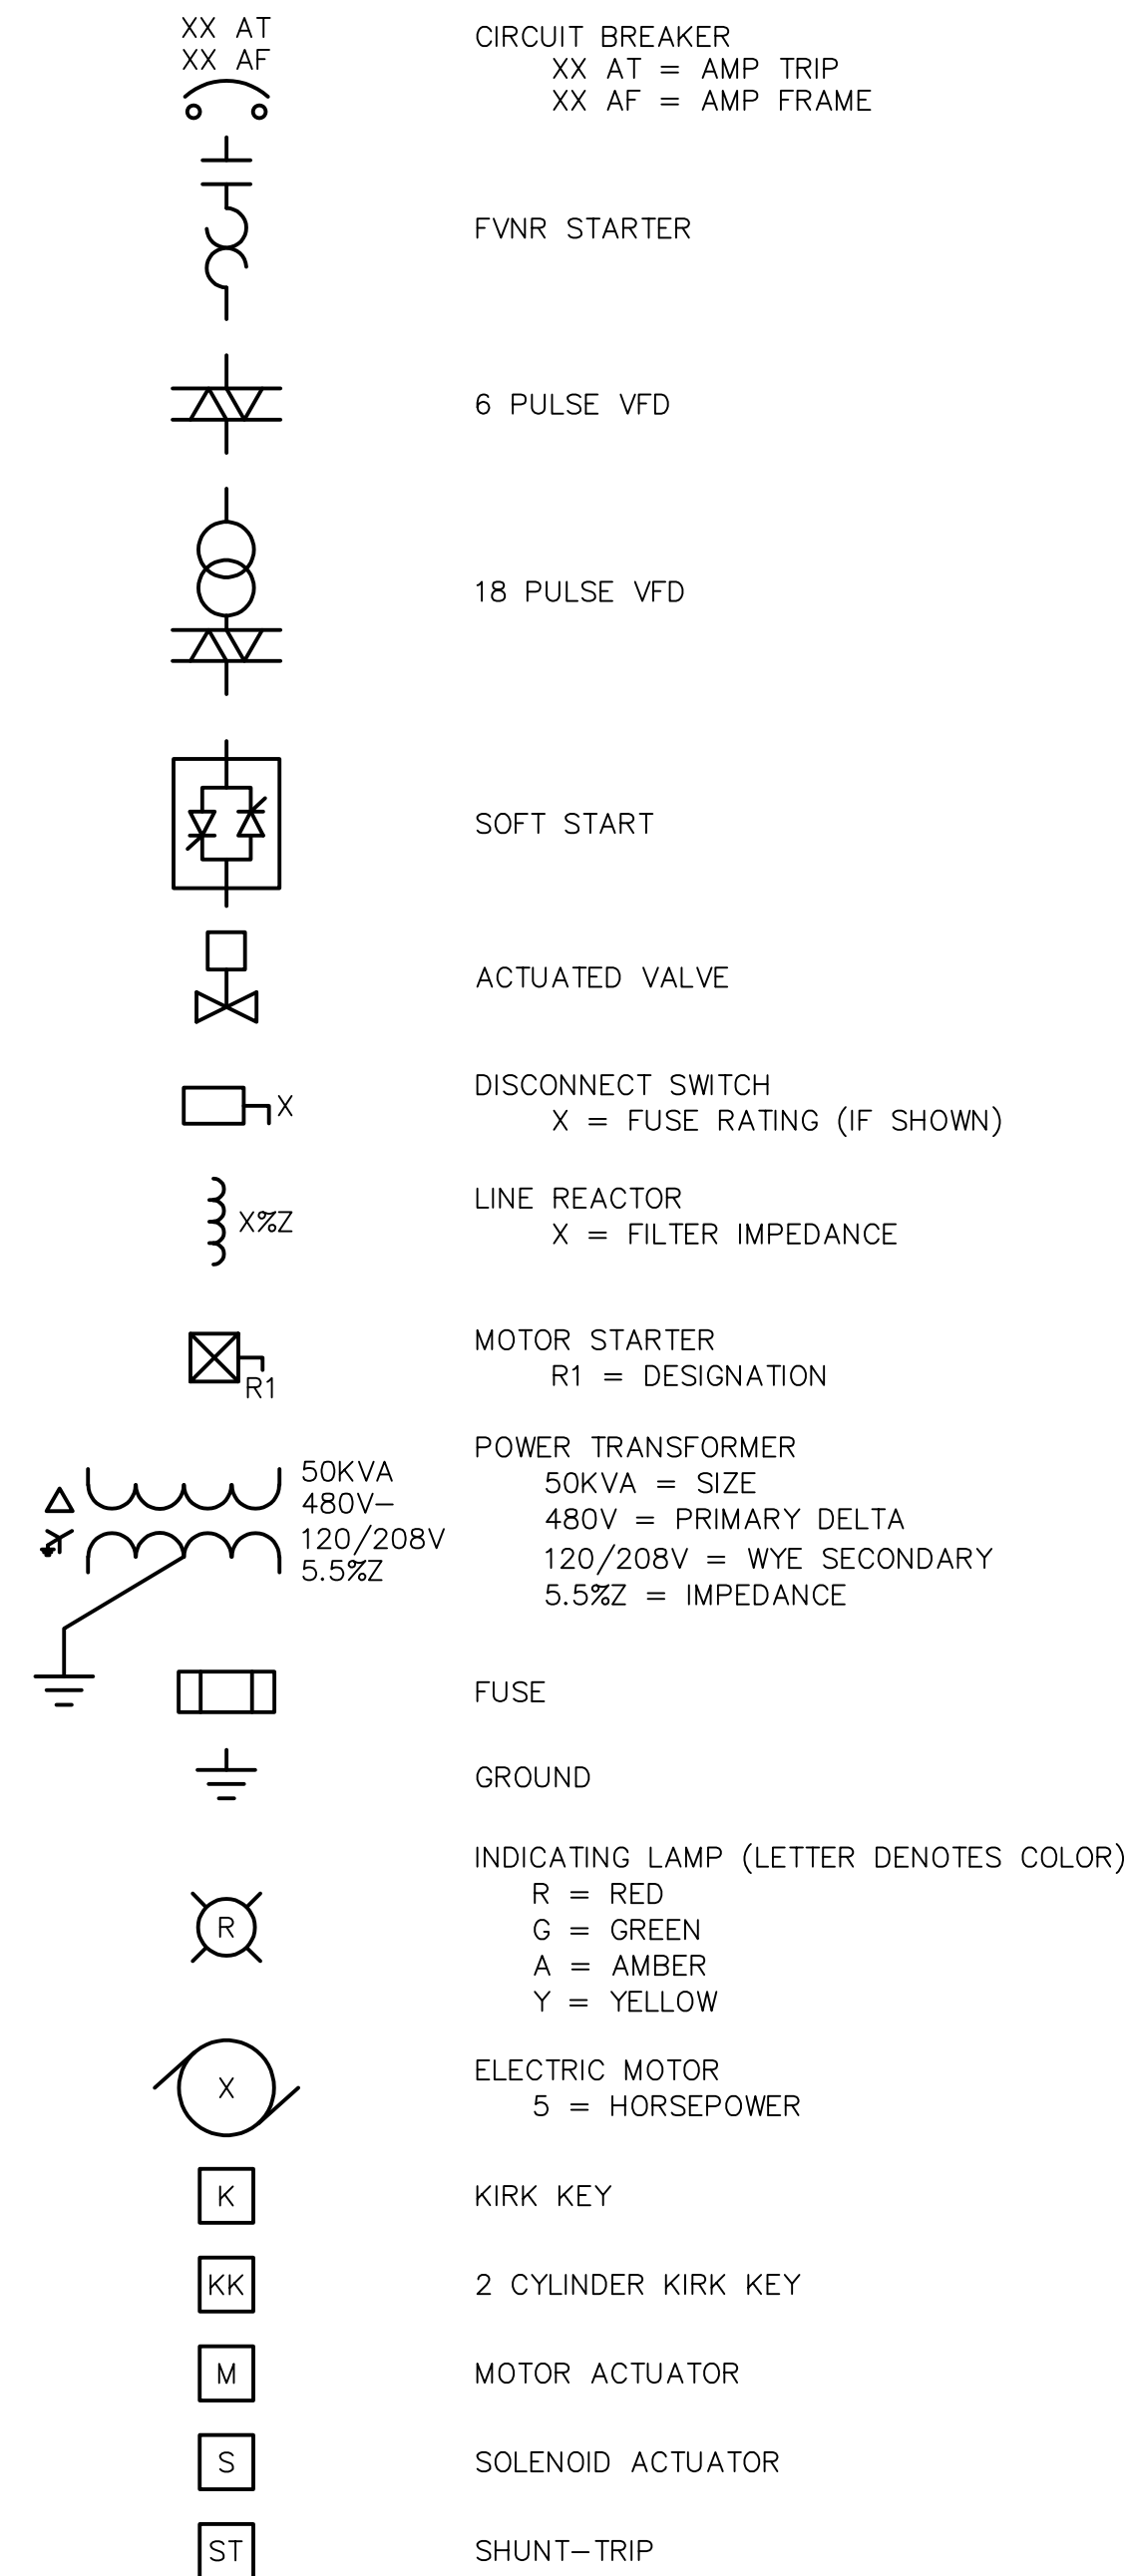


CIRCUIT DECODER

3/4"C. 4#12, #12 GND	THREE #12 PHASE & A #12 NEUTRAL CONDUCTORS WITH A #12 GROUND IN A 3/4" CONDUIT
(4) 4"C. 3#350, #350N, #4/0 GND EA	FOUR 4" CONDUITS WITH PARALLEL SETS OF THREE 350KCMIL PHASE CONDUCTORS, A 350KCMIL NEUTRAL CONDUCTOR AND A 4/0AWG GROUND IN EACH
(2) TC 3#500, #1 GND & #1/0 GND	TWO TRAY CABLES, 3#500KCMIL PHASE AND #1 GND WITH A SUPPLEMENTAL #1/0 GND RUN ALONG WITH THE CABLES IN THE TRAY
1"C. 5#18 STP	1" CONDUIT WITH FIVE SHIELDED TWISTED PAIR CABLES
1"C. (1) 12-FOC	1" CONDUIT WITH ONE 12 STRAND FIBER OPTIC CABLE
1"C. (1) 8PR#16	1" CONDUIT WITH ONE 8 PAIR UNSHIELDED TWISTED PAIR CABLES
2"C. (2) 4PR#18 STP	2" CONDUIT WITH TWO 4 PAIR SHIELDED TWISTED PAIR CABLES


LIGHTING SYMBOLS

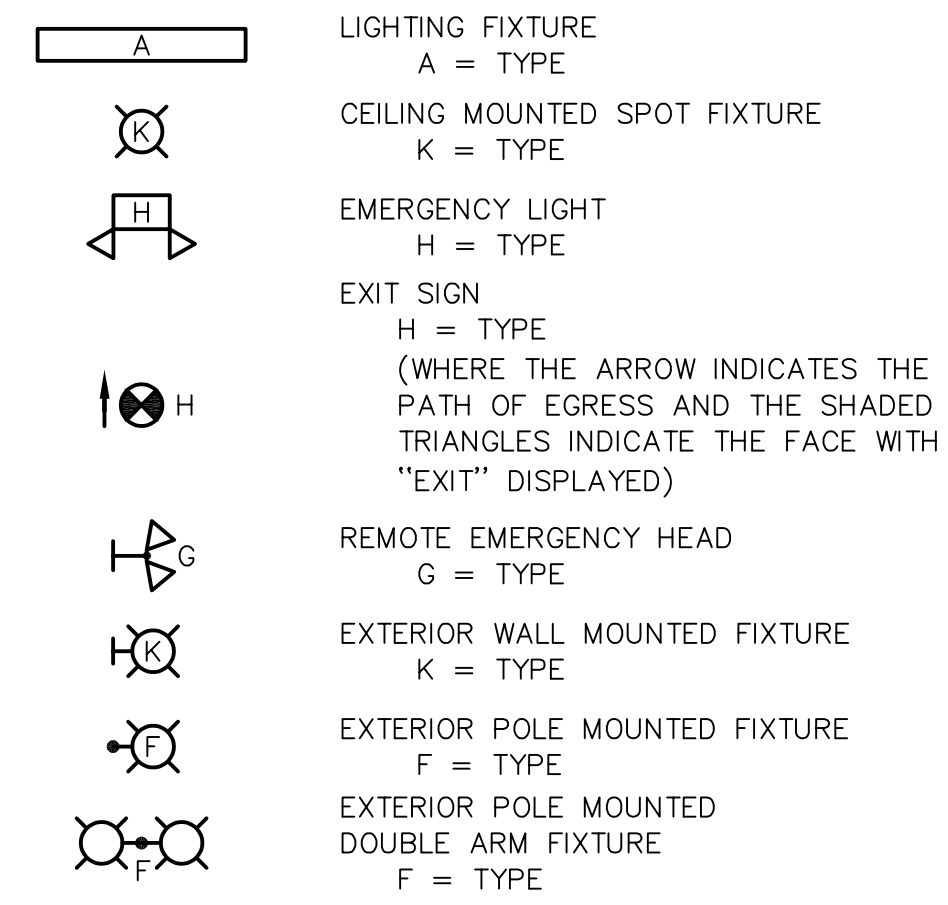

SWITCHING SYMBOLS

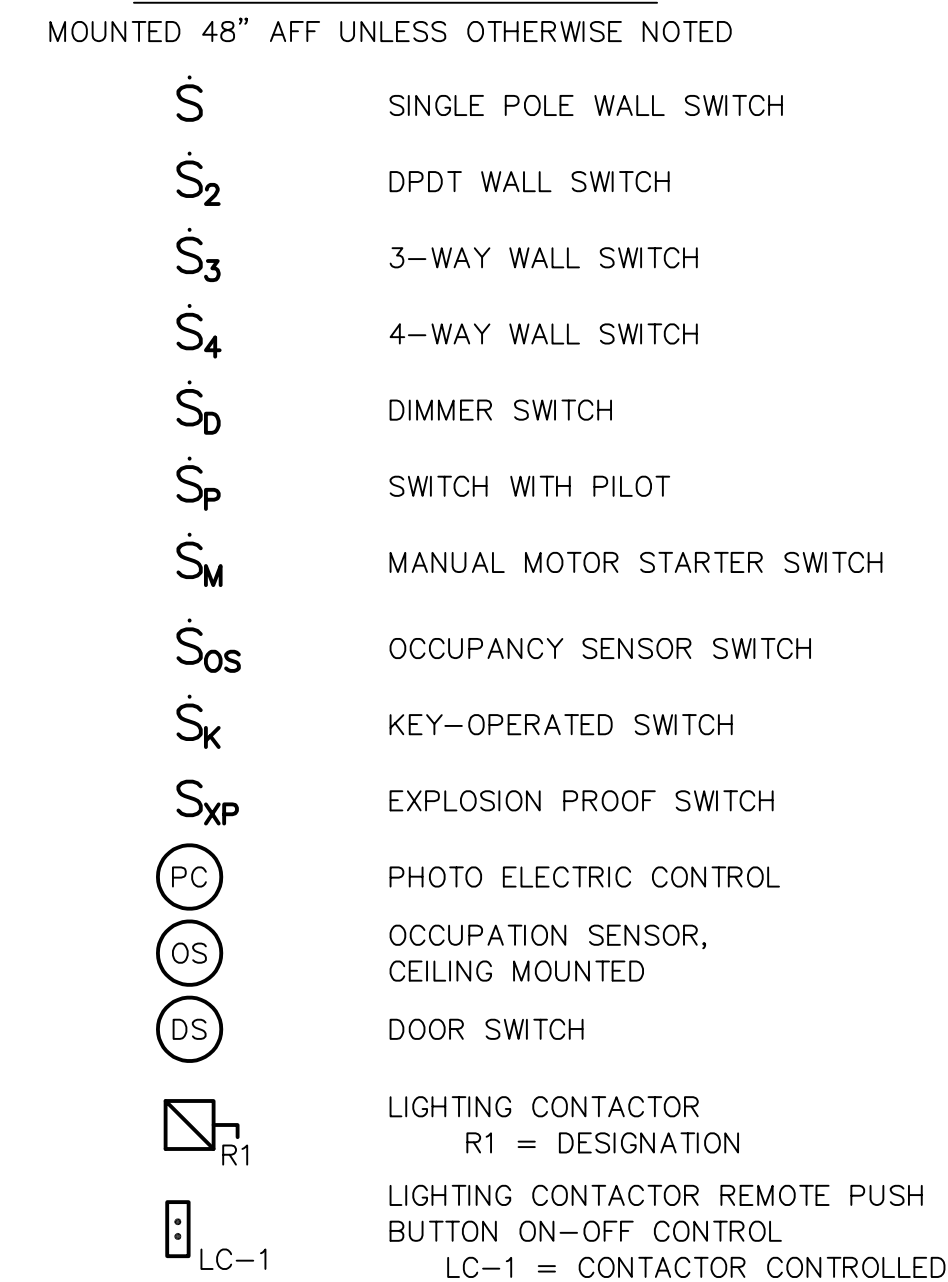

CIRCUITING AND RACEWAY SYMBOLS

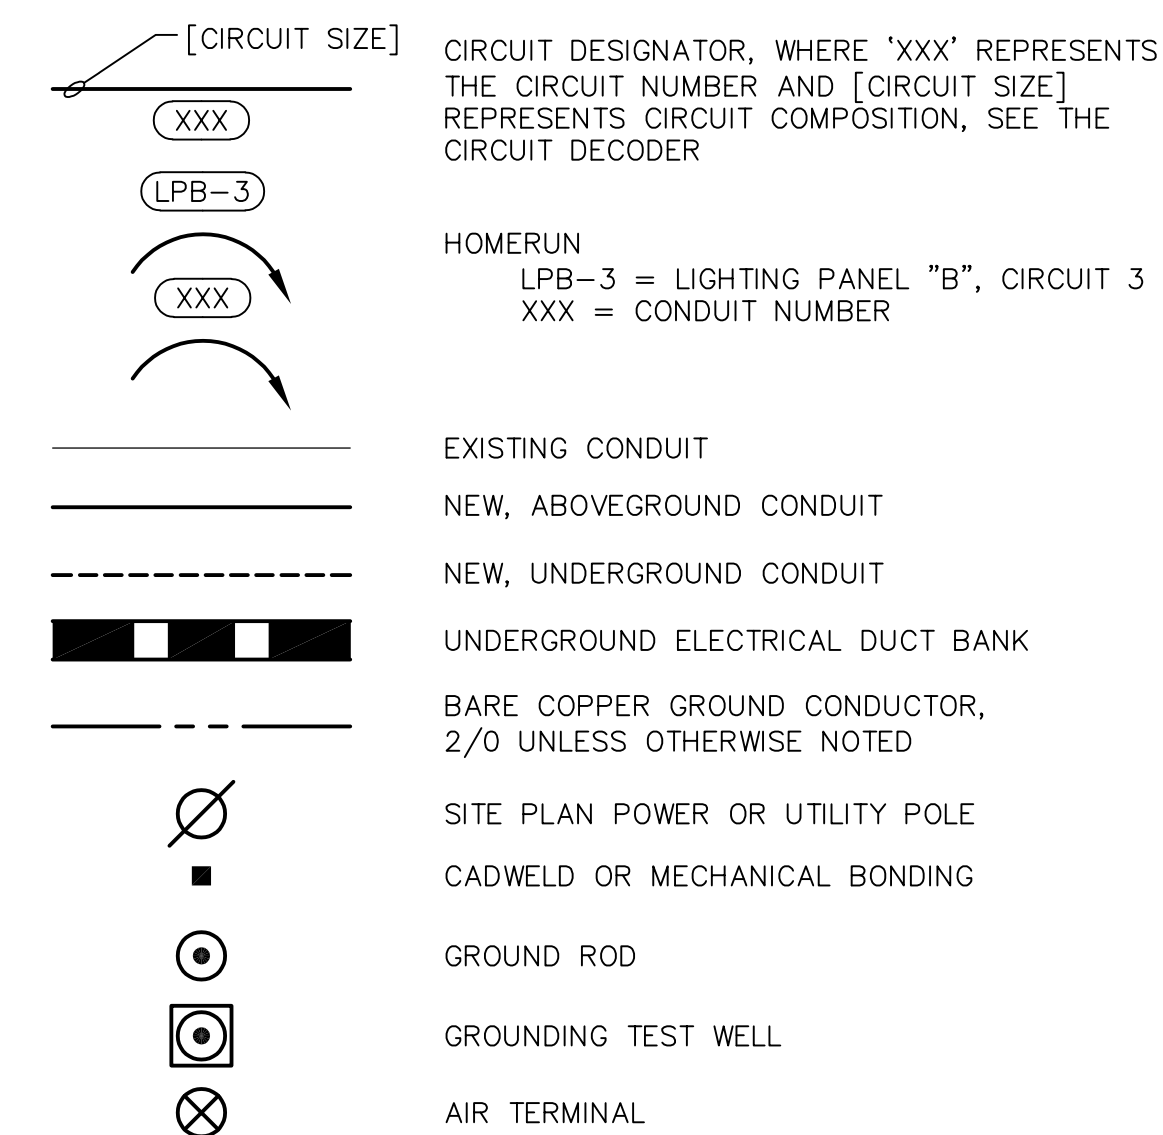


GENERAL NOTES:

- ALL ELECTRICAL EQUIPMENT AND INSTALLATIONS SHALL CONFORM WITH THE REQUIREMENTS OF LATEST APPLICABLE VERSION OF THE INTERNATIONAL BUILDING CODE (IBC) AND NATIONAL ELECTRICAL CODE (NFPA 70) AS ADOPTED BY THE AHJ (AUTHORITY HAVING JURISDICTION), AND UNDERWRITER'S LABORATORIES (UL) REQUIREMENTS.
- ALL WORK SHALL BE INSTALLED IN A NEAT AND WORKMAN LIKE MANNER. REFER TO NECA 1 - GOOD WORKMANSHIP IN ELECTRICAL CONSTRUCTION AND OTHER APPLICABLE NECA STANDARDS. CONDUIT PLANS ARE DIAGRAMMATIC IN NATURE AND NOT INTENDED TO SHOW ALL TURNS, BENDS, FITTINGS, AND SPECIAL INTRICACIES. THIS DOES NOT LIMIT CONTRACTOR'S LIABILITY FOR THE INSTALLATION OF A SOUND AND COMPLETE SYSTEM THAT COMPLIES WITH THE N.E.C. AND LOCAL CODES AND REGULATIONS.
- PRIOR TO PURCHASING ANY MATERIALS OR COMMENCING WORK, CONTRACTOR SHALL FIELD VERIFY ALL EXISTING CONDITIONS, CONDUIT SIZES AND LOCATIONS, EQUIPMENT, ETC. SHOWN ON THE DRAWINGS OR AFFECTING THIS WORK AND SHALL REPORT ANY DEVIATIONS TO THE ENGINEER.
- COORDINATE ALL WORK WITH STRUCTURAL, MECHANICAL, AND OTHER CRAFTS AS REQUIRED. CONTRACTOR SHALL APPRISE HIMSELF OF ALL WORK SHOWN ON OTHER DRAWING FOR VARIOUS ASPECTS OF THIS PROJECTS AND COORDINATE ACCORDINGLY.
- PROVIDE ALL LABOR, MATERIAL, AND EQUIPMENT COMPLETELY TO PROVIDE FULLY OPERATIONAL SYSTEMS.
- ALL ELECTRICAL EQUIPMENT SHALL BE INSTALLED IN ACCORDANCE WITH THE MANUFACTURER'S RECOMMENDATIONS.
- WHERE CONDUIT SIZE AND FILL IS NOT DEFINED ON THE SINGLE LINE OR INTERCONNECTION DIAGRAM, PROVIDE 3/4" CONDUIT WITH 2 #12 AWG AND #12 AWG GROUND CONDUCTORS FOR SINGLE PHASE AND 3/4" CONDUIT WITH 3#12 AWG AND #12 AWG GROUND CONDUCTOR FOR 3 PHASE.
- ALL 120V OR GREATER WIRING FOR DEDICATED OR MULTIPLE CIRCUITS IN THE SAME RACEWAY SHALL INCLUDE AN EQUIPMENT GROUNDING CONDUCTOR.

MECHANICAL COORDINATION:

- CONTRACTOR SHALL COORDINATE CHARACTERISTICS AND REQUIREMENTS OF ALL MECHANICAL EQUIPMENT WITH ELECTRICAL DRAWINGS PRIOR TO ORDERING OR INSTALLING EQUIPMENT. CONTRACTOR SHALL FURNISH EQUIPMENT COMPATIBLE FOR THE VOLTAGES SHOWN ON THE MECHANICAL DRAWINGS.
- ALL MECHANICAL EQUIPMENT REQUIRING ELECTRICAL POWER SHALL BE INSTALLED WITH DISCONNECT SWITCHES AT EACH PIECE OF EQUIPMENT. COORDINATE SWITCH TYPE (FUSED OR NON-FUSED) WITH EQUIPMENT CHARACTERISTICS, MANUFACTURER'S RECOMMENDATIONS, AND THE MECHANICAL DRAWINGS.

DEMOLITION AND MODIFICATION

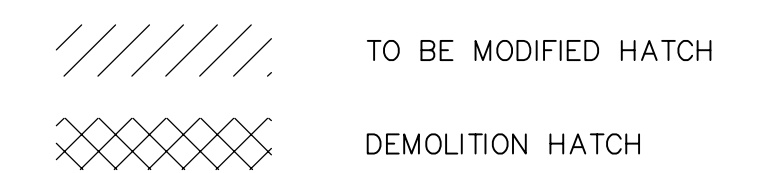

Date	Description	No.
8/28/24	ISSUED FOR REBID	01
Revisions		

STATE OF CONNECTICUT
WILLIAM F. BLEILER
PROFESSIONAL ENGINEER
33415
6/29/24

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Project
PHASE II - 133 PUMP STATION
FAIRFIELD COUNTY BROOKFIELD CONNECTICUT

Drawing Title
ELECTRICAL LEGEND AND SYMBOLS

Project No.
190093201


Date
8/28/2024

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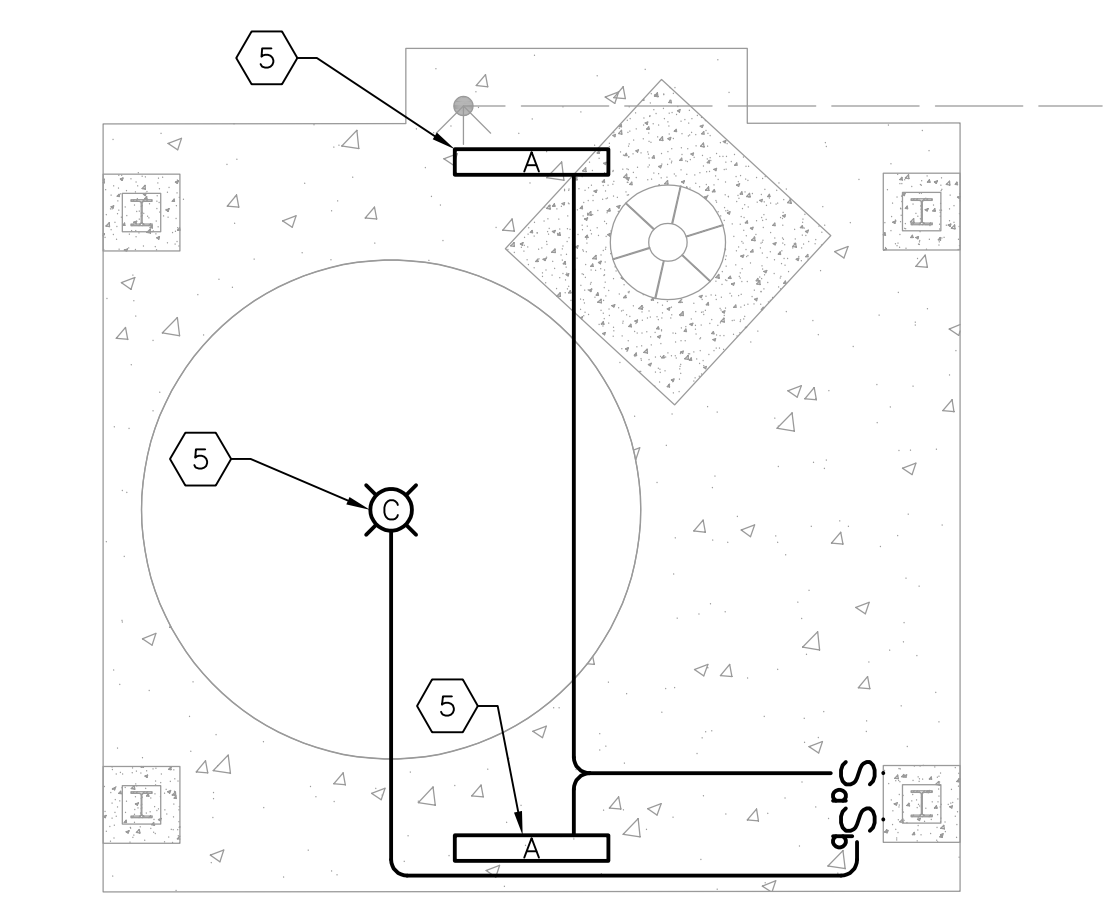
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E-001

Sheet 2 of 7




- KEY NOTES:**
- SEE DRAWING E-603 FOR AIR GAP ENCLOSURE DETAILS. AIR GAP ENCLOSURE SHALL BE MOUNTED 3'-0" FROM WET WELL AND VALVE PIT HATCHES MINIMUM, AND 5'-0" FROM WET WELL AND VALVE PIT VENTS MINIMUM.
 - THIS AREA IS A CLASS I DIVISION 1 LOCATION. ALL ELECTRICAL INSTALLATIONS TO BE INSTALLED IN ACCORDANCE WITH NEC ARTICLE 501.
 - CONTRACTOR SHALL RETAIN AND RE-USE EXISTING 100 AMP DISCONNECT SWITCHES FOR NEW PUMPS. CONTRACTOR SHALL PROVIDE TEMPORARY DISCONNECT SWITCHES TO FEED EXISTING PUMPS UNTIL NEW STATION IS COMMISSIONED.
 - HOIST/JIB CRANE SHALL BE INSTALLED OUTSIDE OF ALL CLASSIFIED AREAS, 3'-0" FROM WET WELL AND VALVE PIT HATCHES MINIMUM, AND 5'-0" FROM WET WELL AND VALVE PIT VENTS MINIMUM.
 - INSTALL LIGHT FIXTURES ON WET WELL SHELTER CEILING. PROVIDE NEMA 4X LIGHT SWITCH, MOUNTED TO WET WELL SHELTER POST, FOR TYPE 'A' FIXTURES. PROVIDE SEPARATE NEMA 4X LIGHT SWITCH, MOUNTED TO WET WELL SHELTER POST, FOR TYPE 'C' FIXTURE.
 - THIS AREA IS CLASS I, DIVISION 2 LOCATION. ALL ELECTRICAL INSTALLATIONS TO BE INSTALLED IN ACCORDANCE WITH NEC ARTICLE 501.

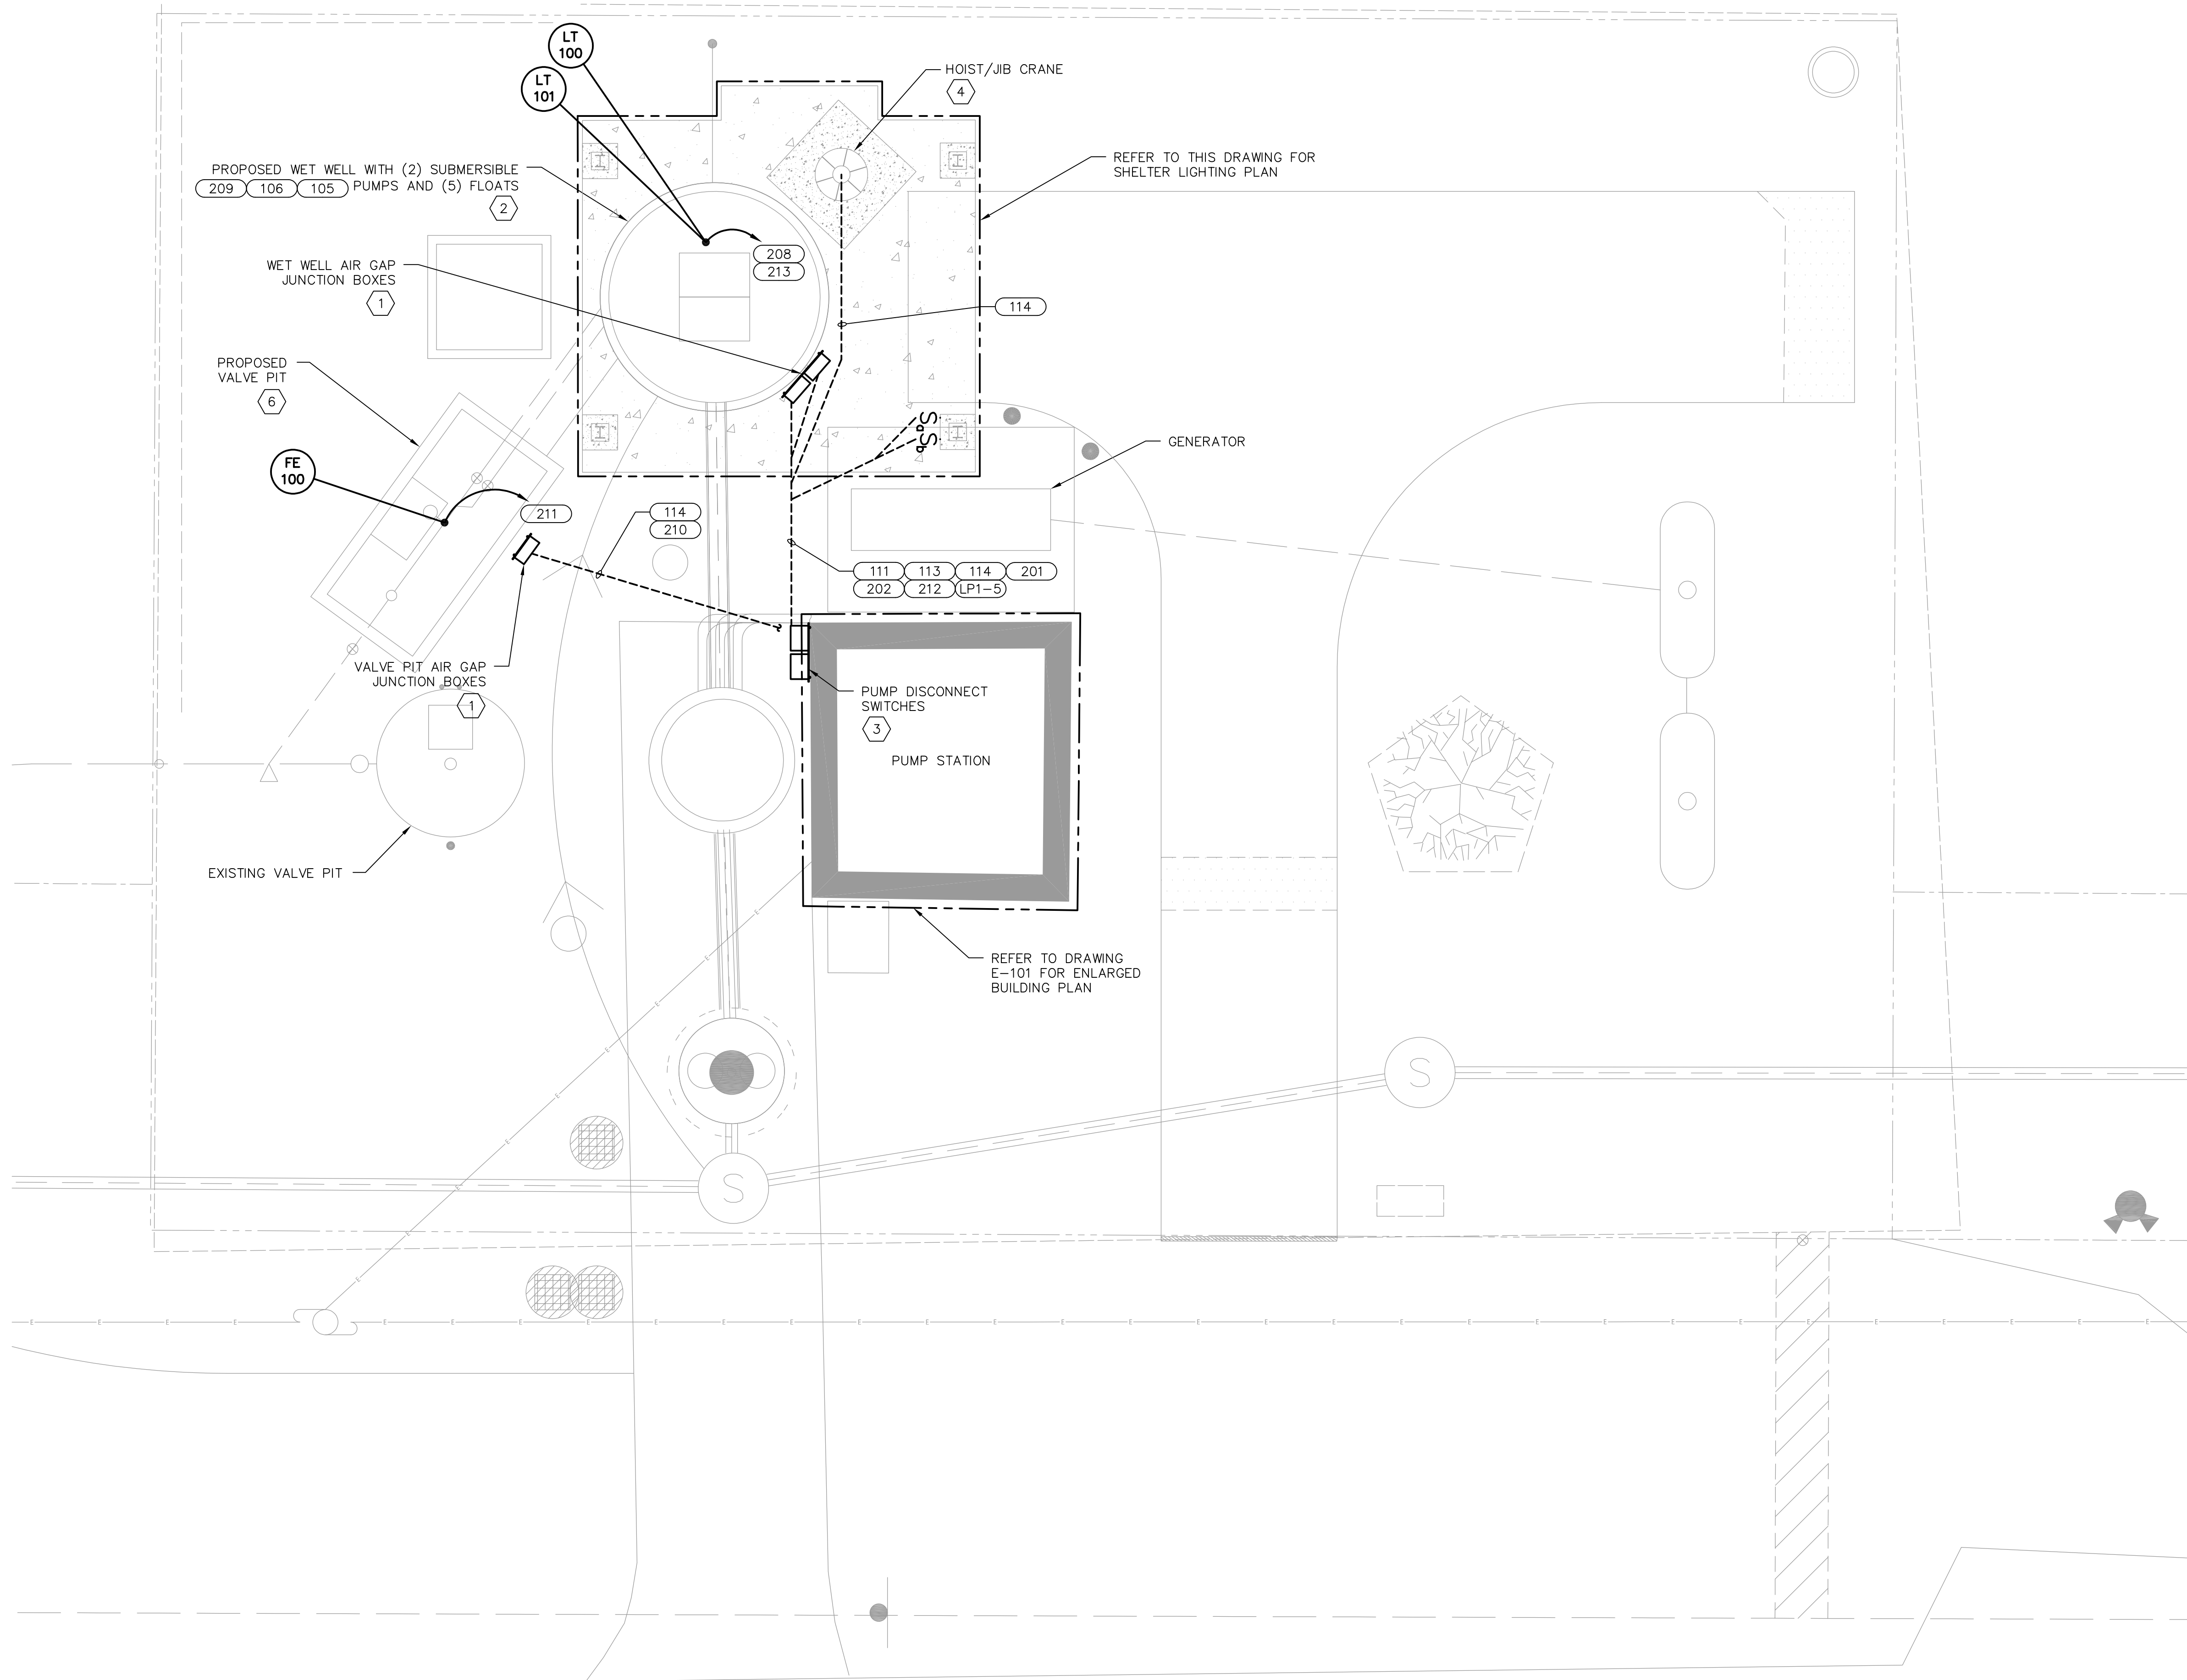

ELECTRICAL SITE PLAN
 1"=5'-0" 0 5 10 15
 SCALE IN FEET

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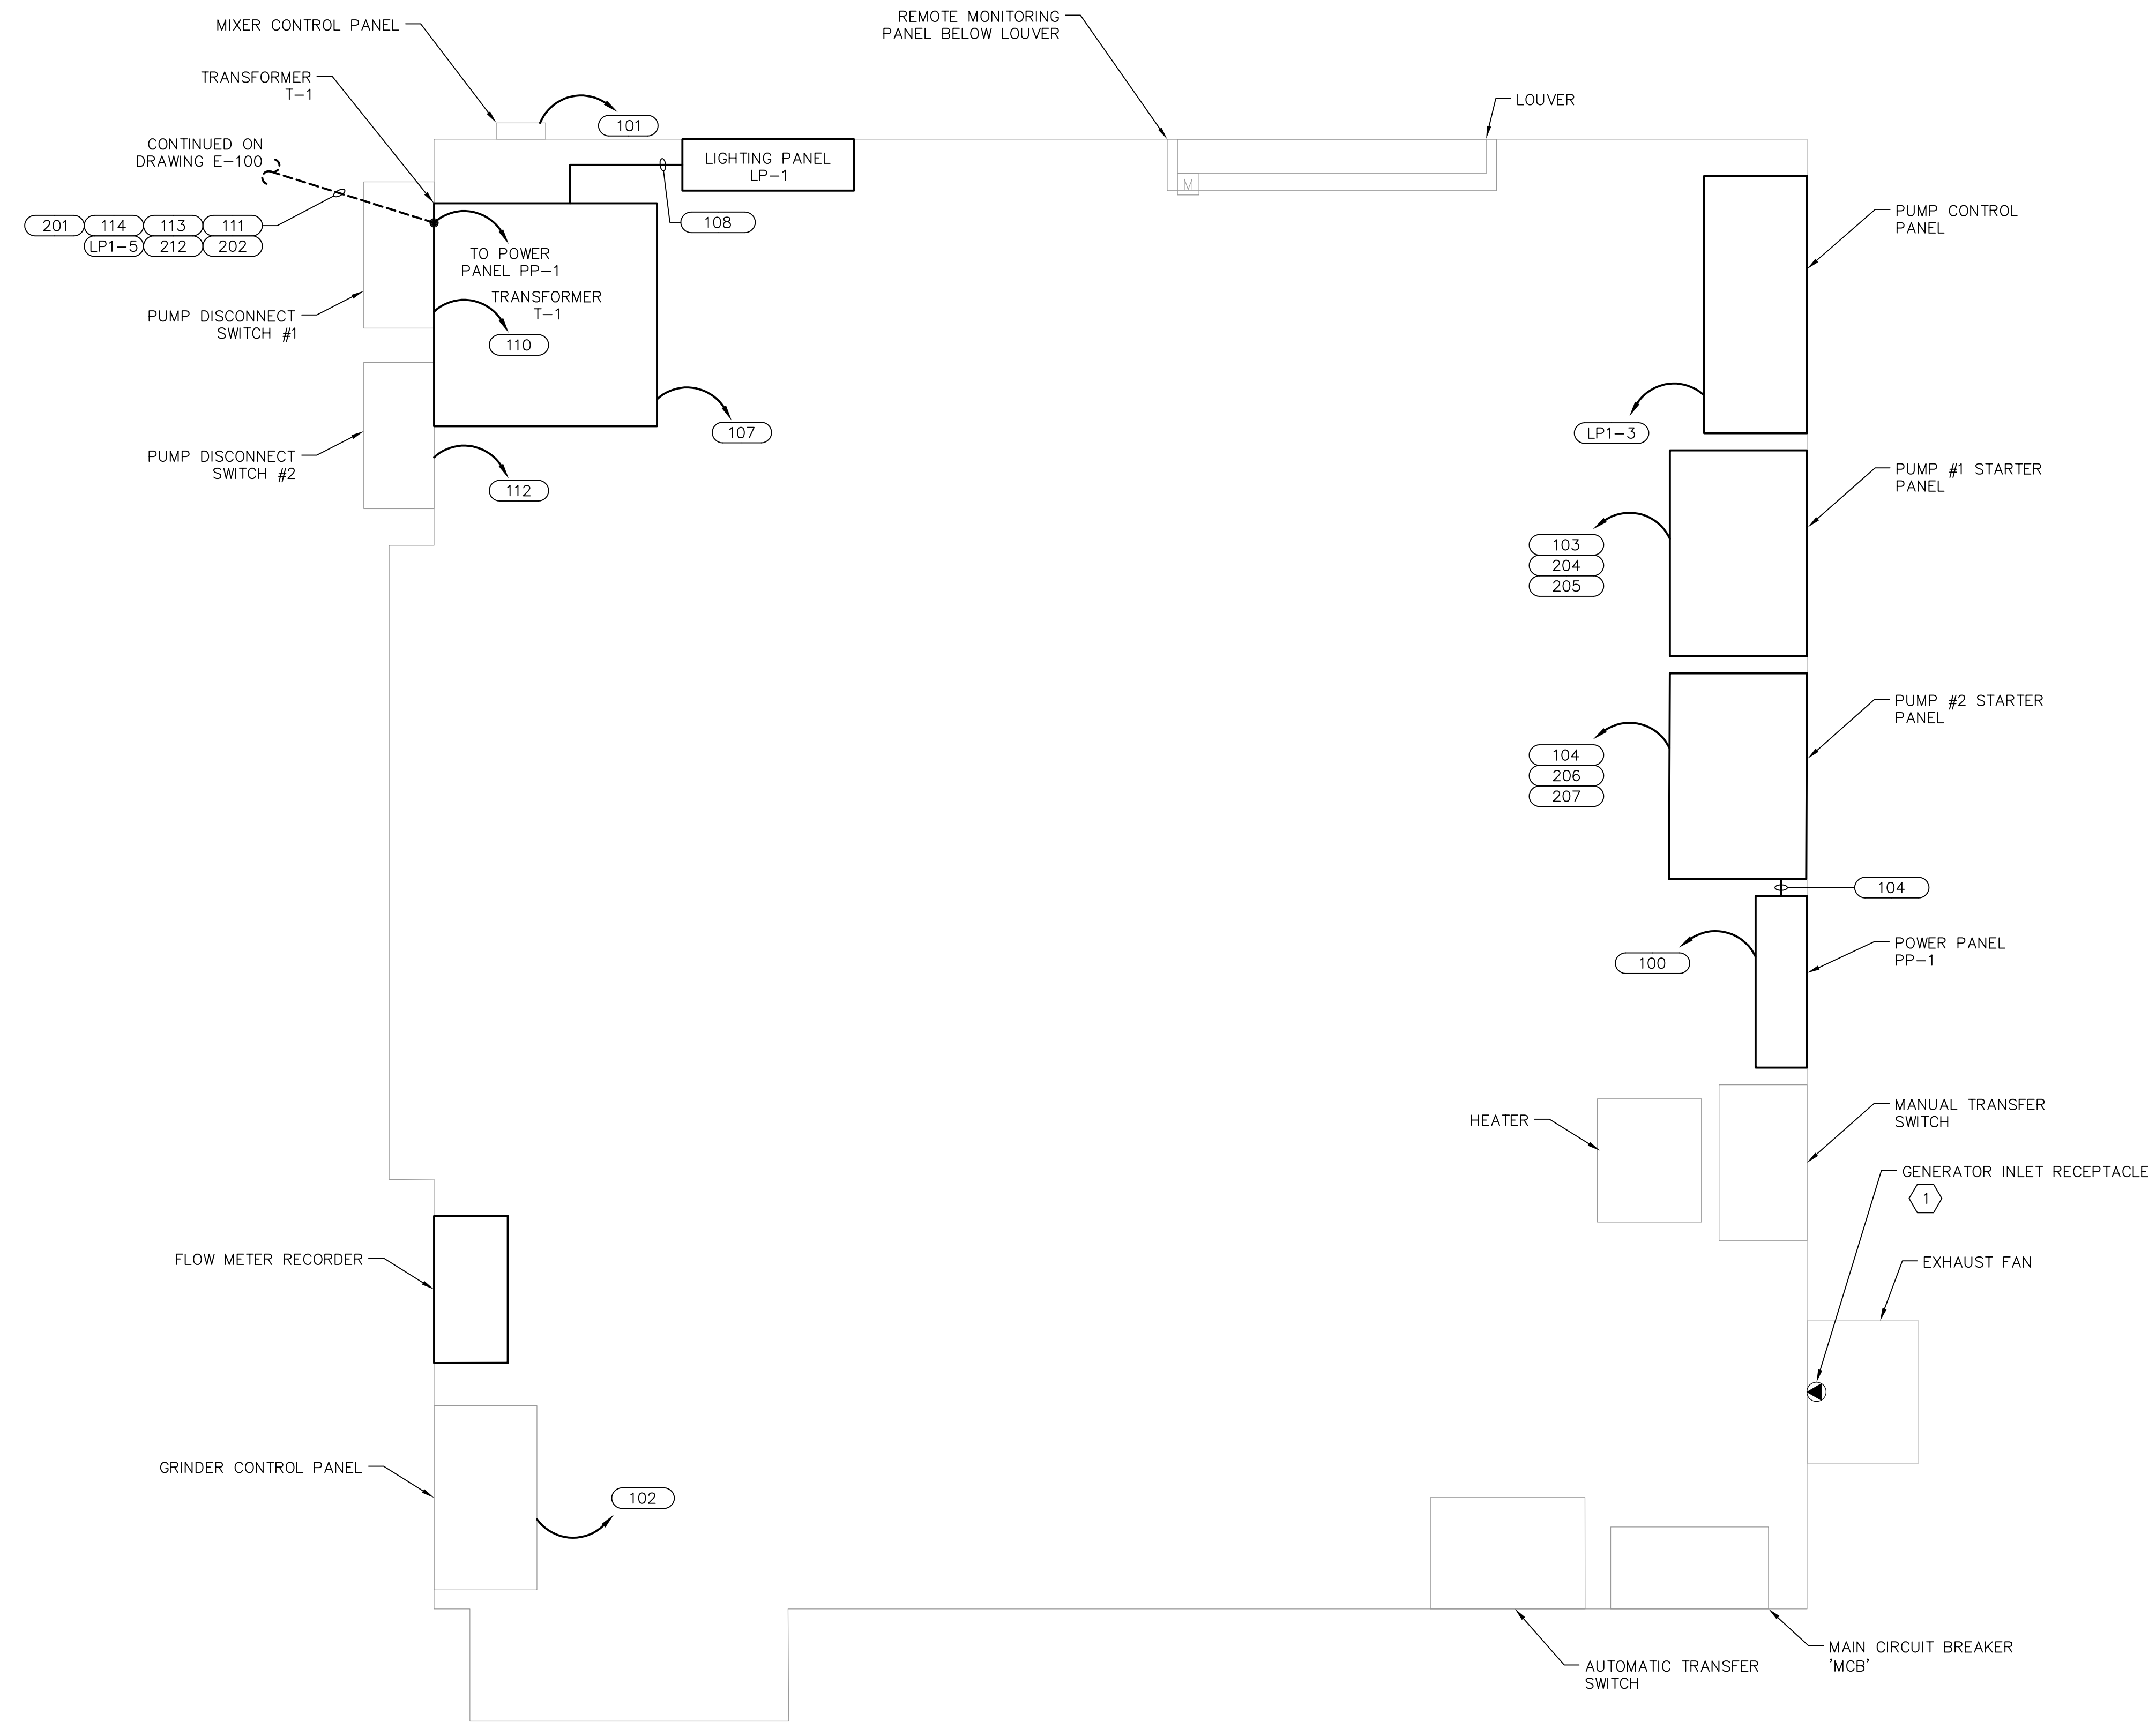

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Project
 PHASE II - 133
 PUMP STATION
 FAIRFIELD COUNTY BROOKFIELD CONNECTICUT

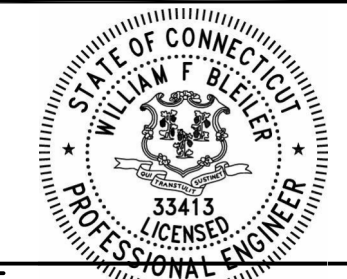
Drawing Title
 ELECTRICAL
 SITE PLAN

Project No.
 190093201
Date
 8/28/2024
Drawn By
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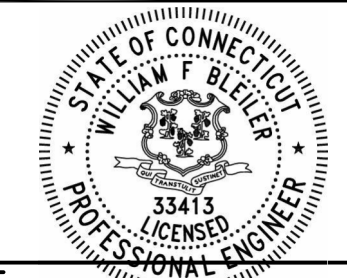


- KEY NOTES:**
- CONTRACTOR SHALL SECURELY RE-MOUNT EXISTING GENERATOR RECEPTACLE ON BUILDING EXTERIOR FOR FUTURE CONNECTION OF PORTABLE GENERATOR.
 - PROVIDE 3/4" CONDUIT WITH 3 #12 AWG.

ELECTRICAL POWER PLAN
 1"=1'-0"
 0 1 2 3
 SCALE IN FEET

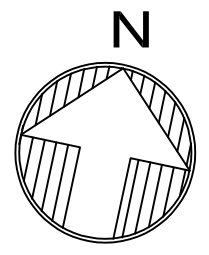

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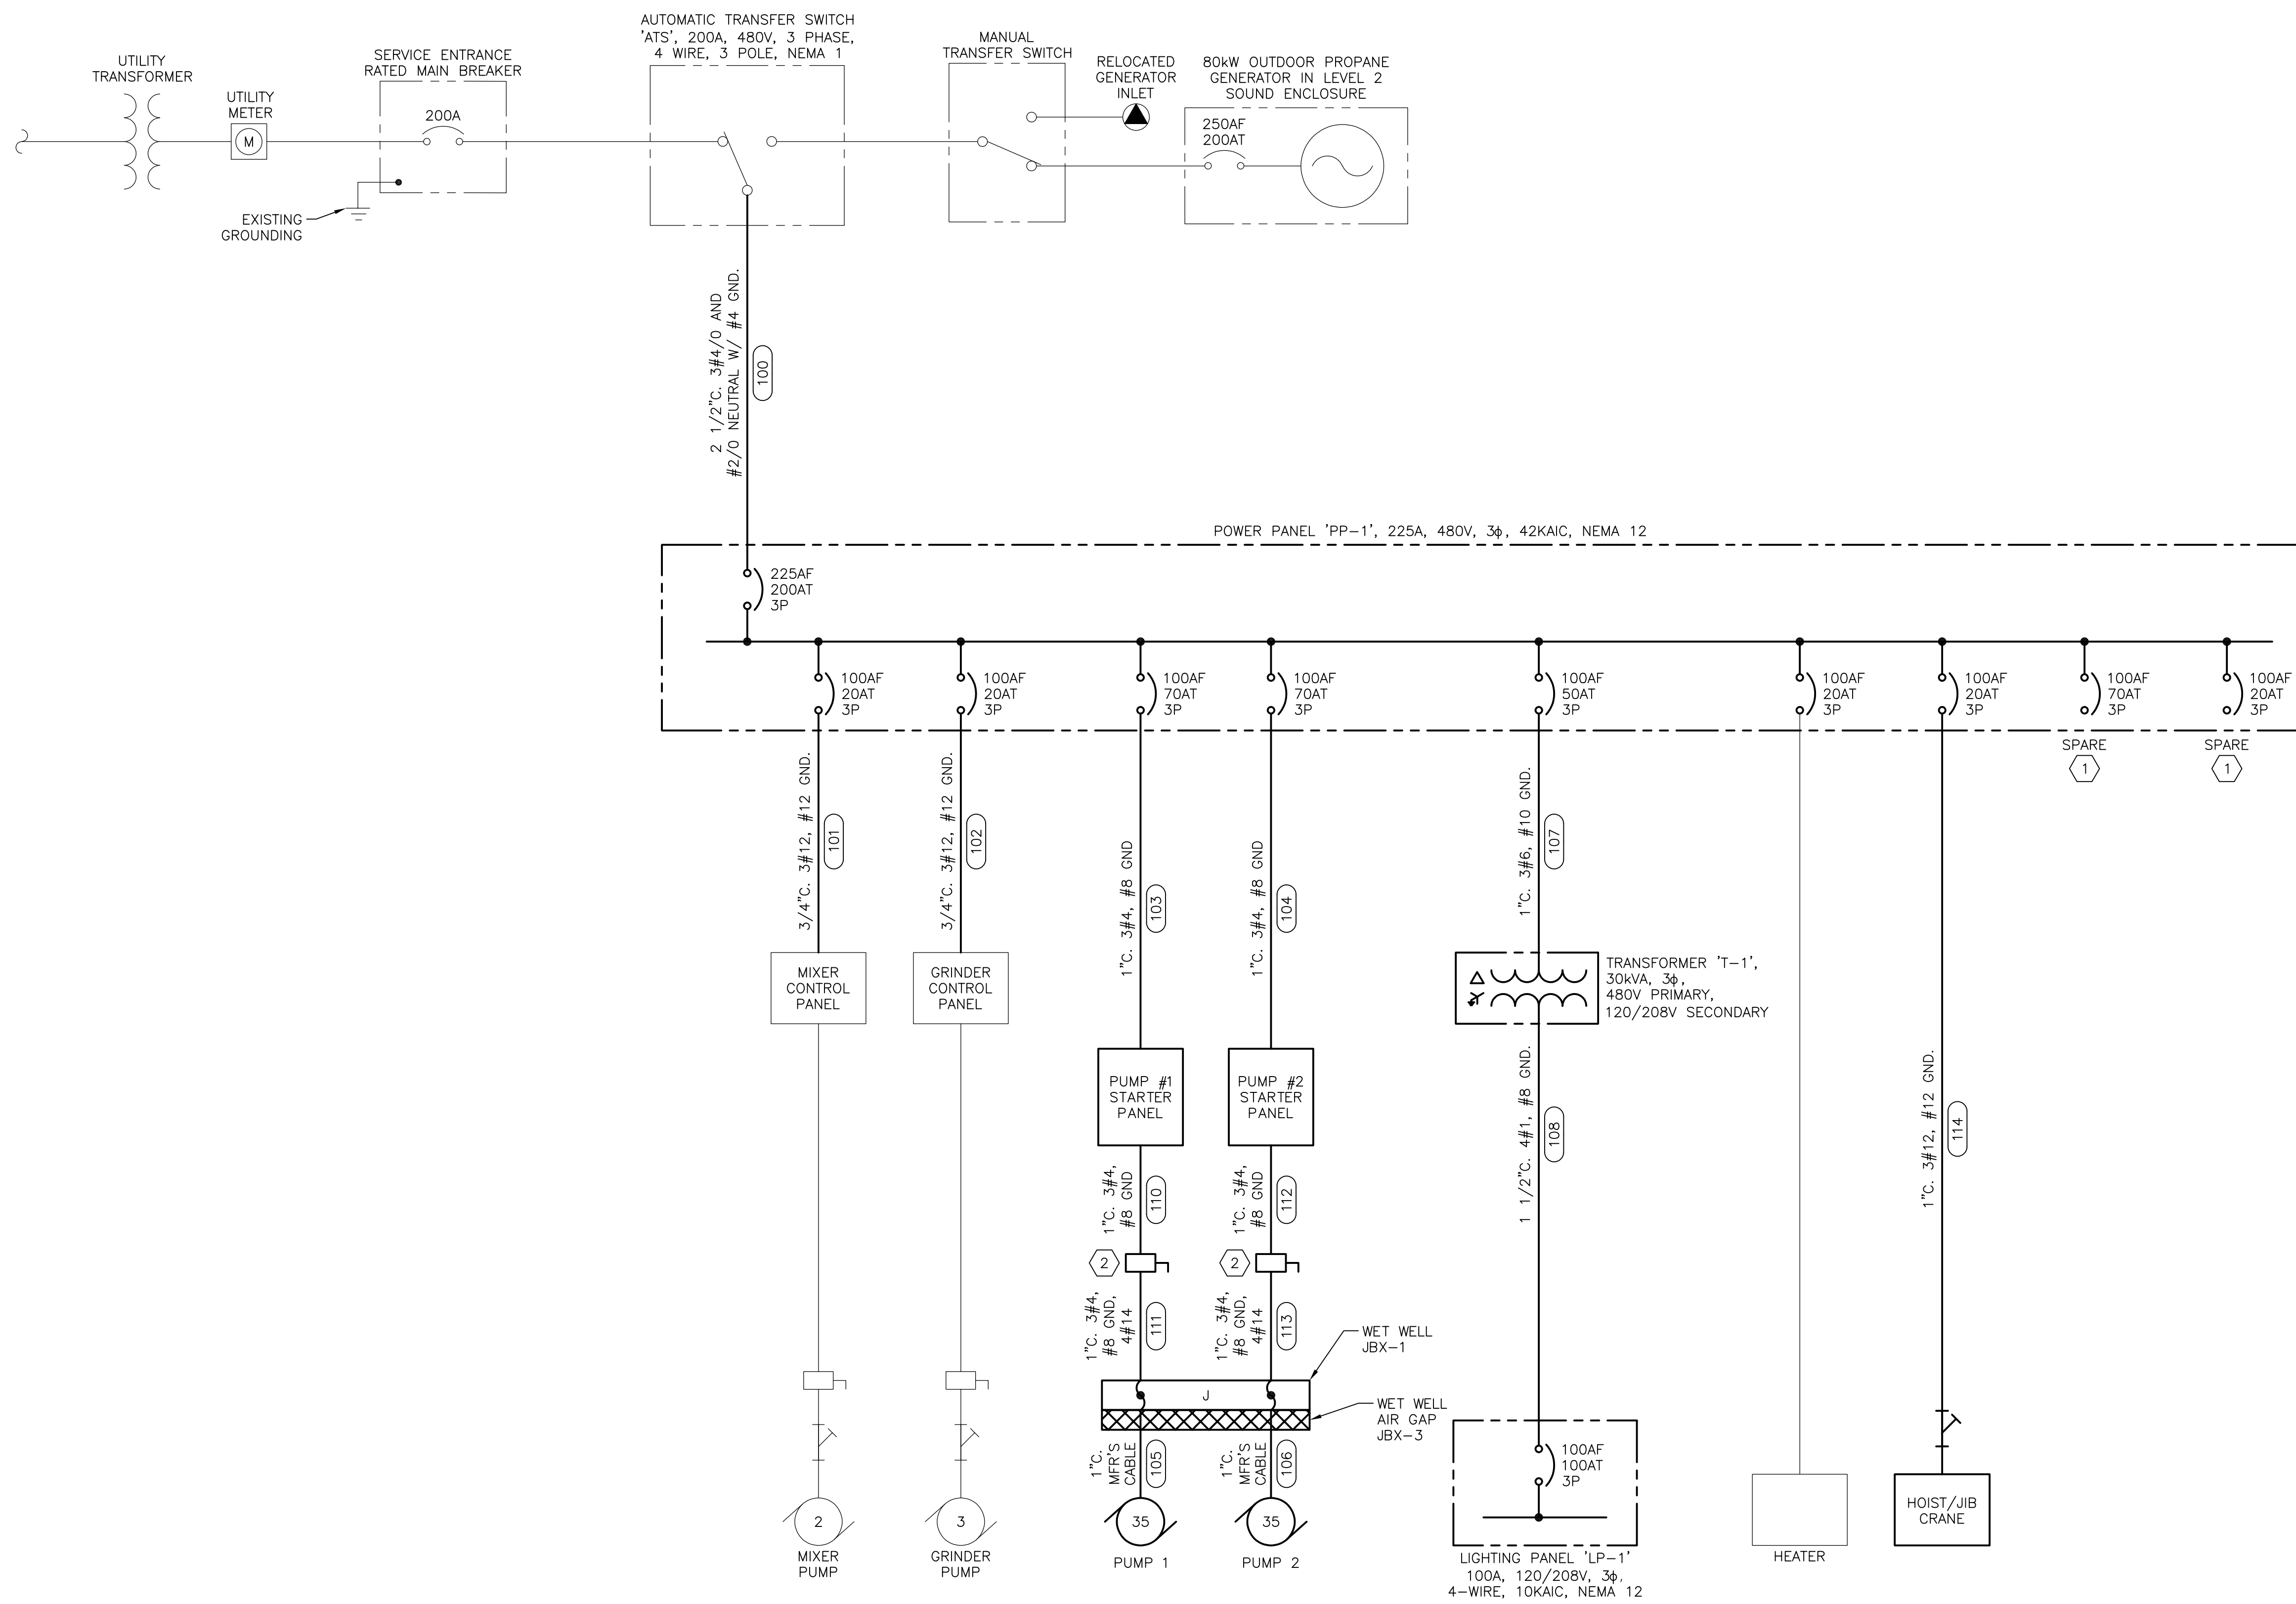
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Drawing Title
 ELECTRICAL
 POWER PLAN

Project No.
 190093201
Date
 8/28/2024
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Checked By
 HRS


E-101
 Sheet 4 of 7



- KEY NOTES:**
- CONTRACTOR SHALL PROVIDE CIRCUIT BREAKERS AS REQUIRED, WITH A MINIMUM OF ONE SPARE BREAKER PER EACH SIZE IN-USE BREAKER.
 - CONTRACTOR SHALL RETAIN AND RE-USE EXISTING 100 AMP DISCONNECT SWITCHES FOR NEW PUMPS. CONTRACTOR SHALL PROVIDE TEMPORARY DISCONNECT SWITCH TO FEED EXISTING PUMPS UNTIL NEW STATION IS COMMISSIONED.

SINGLE LINE DIAGRAM

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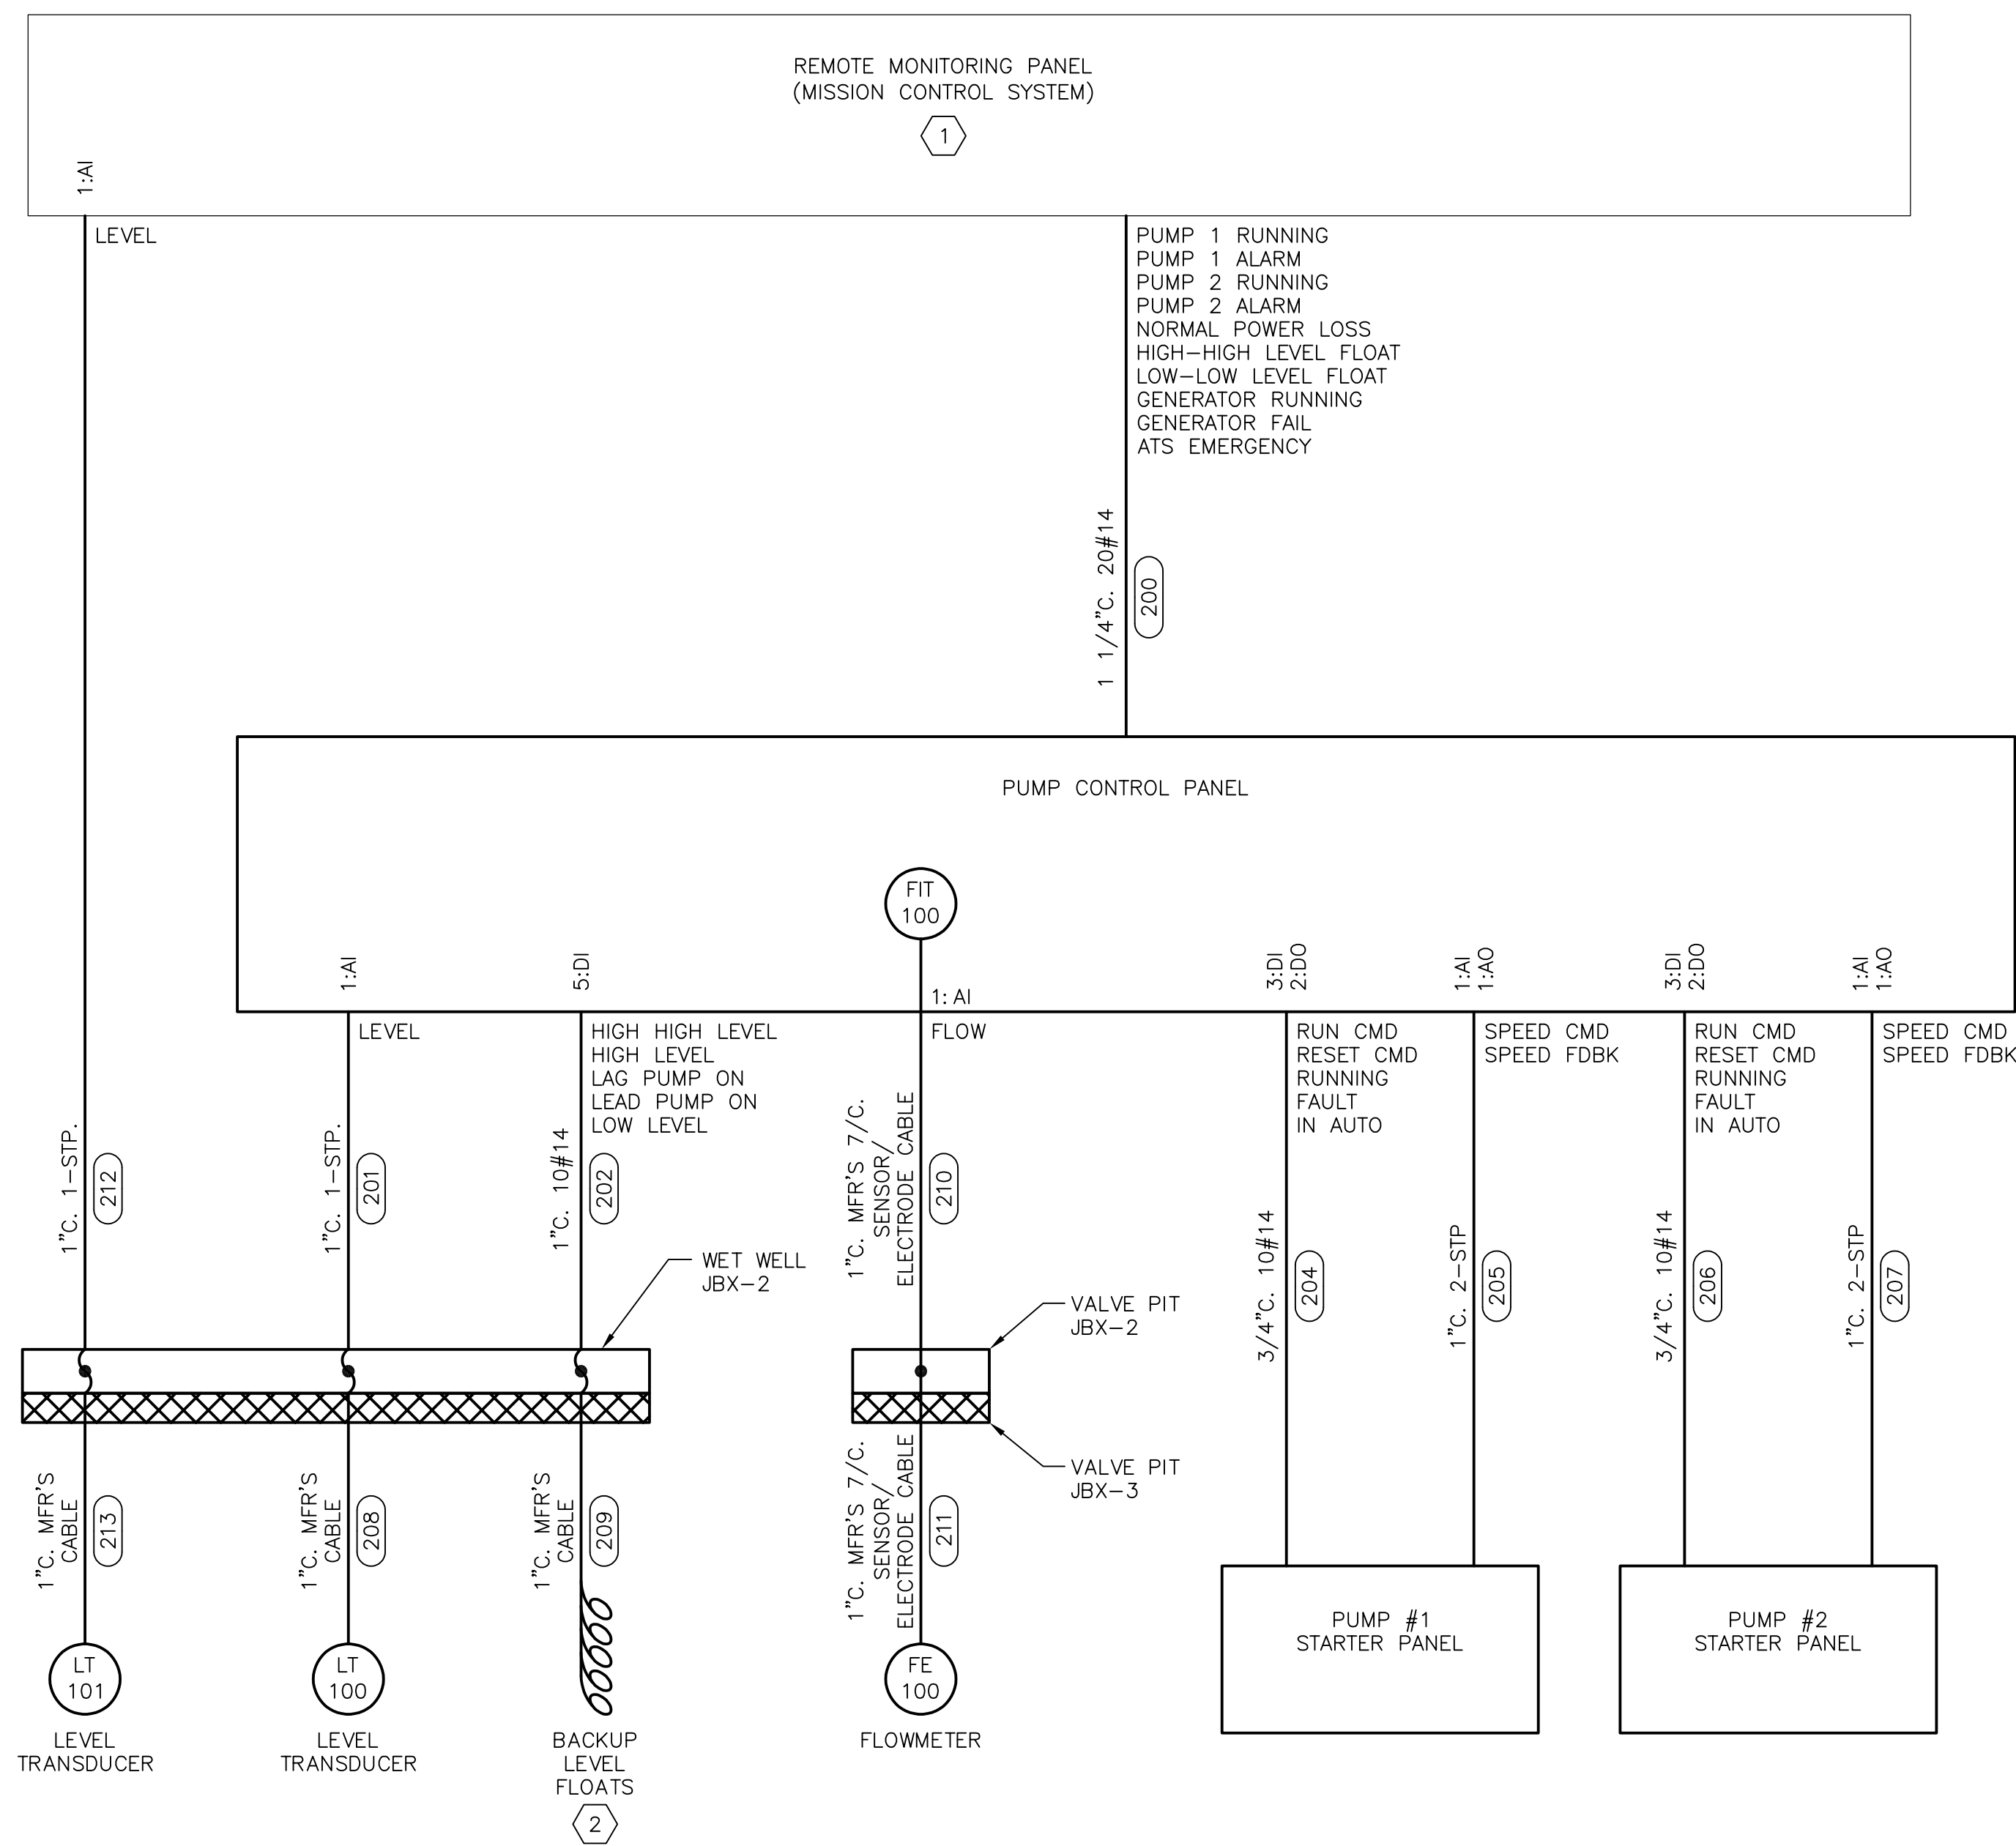
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Project
PHASE II - 133 PUMP STATION
 FAIRFIELD COUNTY BROOKFIELD CONNECTICUT

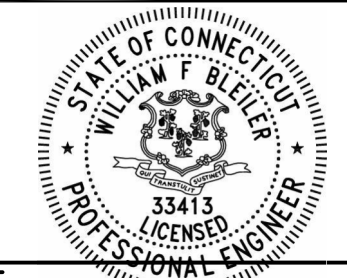Drawing Title
ELECTRICAL SINGLE LINE DIAGRAM

Project No. 190093201
 Date 8/28/2024
 Drawn By TOS
 Checked By HRS


E-601
 Sheet 5 of 7



INTERCONNECTION DIAGRAM

TYPE	MANUFACTURER AND SERIES	DESCRIPTION	VOLTS (WATTS)	REMARKS
A	CURRENT LIGHTING COLUMBIA LXEP	4' ENCLOSED AND GASKETED LED FIXTURE; FIBERGLASS HOUSING WITH F1 WEATHERABILITY RATING AND TAMPER RESISTANT LATCHES; DEEP FROSTED ACRYLIC LENS, IMPACT MODIFIED; WET LOCATION LISTED; 4000K COLOR TEMP, MEDIUM LUMEN OUTPUT	120 (47)	
C	CURRENT LIGHTING BEACON SRT2 EDGE-LIT	CEILING MOUNTED EDGE-LIT LED FIXTURE; DIE-CAST ALUMINUM TAMPER RESISTANT HOUSING WITH CORROSION RESISTANT POWDER COAT FINISH, SILICONE GASKETED; WET LOCATION LISTED; 4000K, 70 CRI COLOR TEMP, 14700 LUMENS, TYPE 5 CONCENTRATED DISTRIBUTION	120 (140)	

LIGHTING FIXTURE SCHEDULE

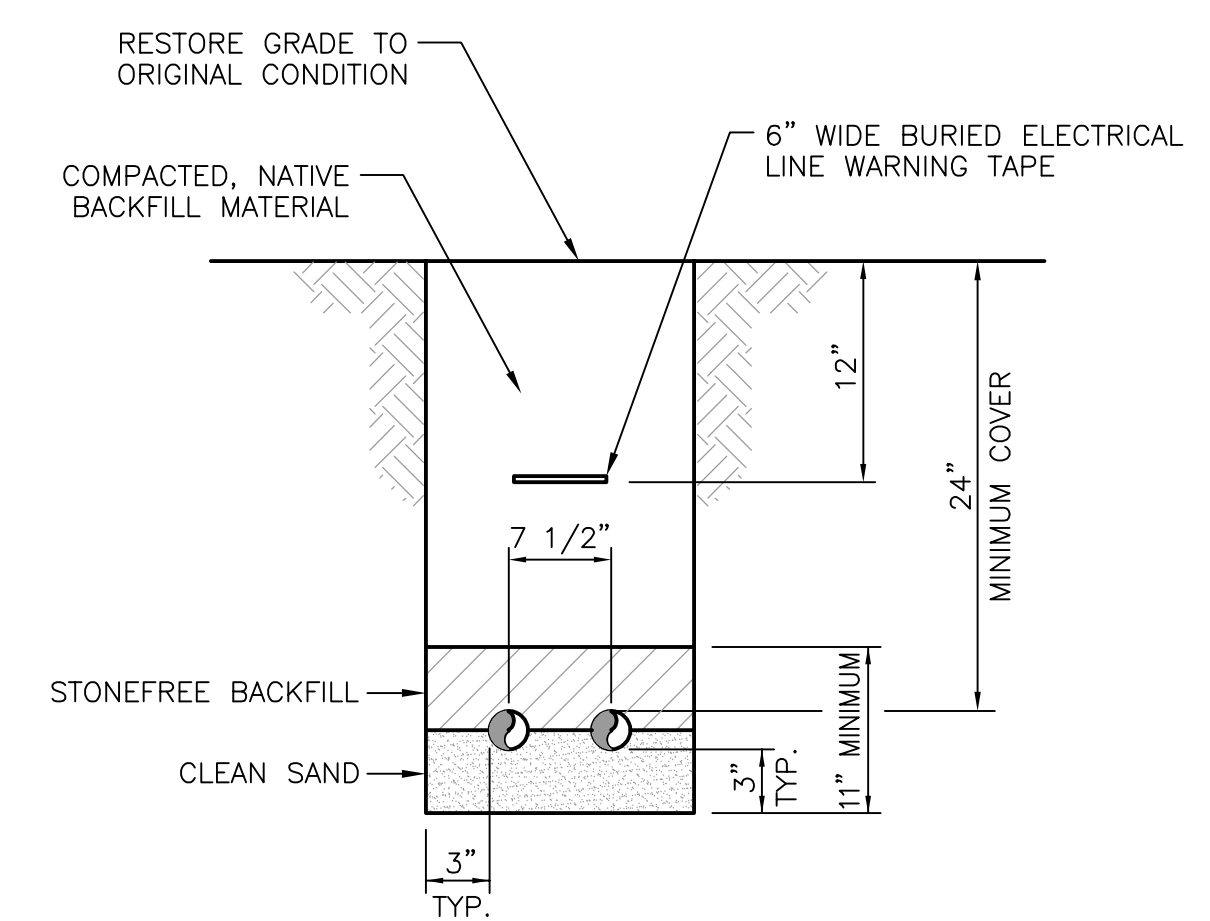

TYPICAL UNDERGROUND CONDUIT DETAIL
NOT TO SCALE

- KEY NOTES:**
1. REMOTE MONITORING PANEL IS EXISTING, ONLY NEW SIGNALS ARE SHOWN. EXISTING SIGNALS ARE TO REMAIN UNLESS OTHERWISE NOTED.
 2. FLOATS SHALL BE RACK MOUNTED.
 3. TERMINATE EXISTING CIRCUITRY WIRING IN NEW LIGHTING PANEL.
 4. CONTRACTOR SHALL FIELD VERIFY EXISTING LIGHTING PANEL LOADS FOR RECONNECTION. CONTRACTOR SHALL COORDINATE WITH OWNER TO CONFIRM ALL EXISTING LOADS ARE TO BE RE-POWERED.
 5. PROVIDE EPD TYPE CIRCUIT BREAKER.

120/208 V. 3 PHASE 60HZ 4 WIRE LIGHTING PANEL LP1 SCHEDULE											
SERVICE	C/B	KVA	NO	A	B	C	N	NO	KVA	C/B	SERVICE
OUTDOOR LIGHTS	20A		1					2		20A	INDOOR LIGHTS
PUMP CONTROL PANEL	20A		3					4		20A	SPARE
WET WELL LIGHTS	20A		5					6		20A	CHART RECORDER/FLOW
SPARE	20A		7					8			
SPARE	20A	2P	9					10		20A 3P	GENERATOR LOAD CENTER
DAY TANK	20A		11					12			
GENERAL RECEPTACLES	20A		13					14		20A	EXHAUST FAN
GRINDER PIT LIGHTS & RECEPT	20A		15					16		20A	VALVE VAULT LIGHTS & RECEPT
INDOOR LIGHTS	20A		17					18		20A	REMOTE MONITORING PANEL
SPARE	20A		19					20		20A	SPARE
SPARE	20A		21					22		20A	SPARE
SPARE	20A		23					24		20A	SPARE
SPARE	20A		25					26			
SPARE	20A		27					28		20A 3P	SPARE
SPARE	20A		29					30			

PANEL MTD: SURFACE	TYPE: NQ
MANUFACTURER: SQUARE 'D'	PANEL LOADING SCHEDULE
MAIN BREAKER: 100A	PHASE
FEEDER SIZE:	WATTS (KW)
BRANCH BREAKERS	A
NO. POLES	B
AMPS.	C
	CONNECTED LOAD
	SPARE
	TOTAL LOAD

LIGHTING PANEL 'LP-1' PANEL SCHEDULE

Date	Description	No.
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STATE OF CONNECTICUT
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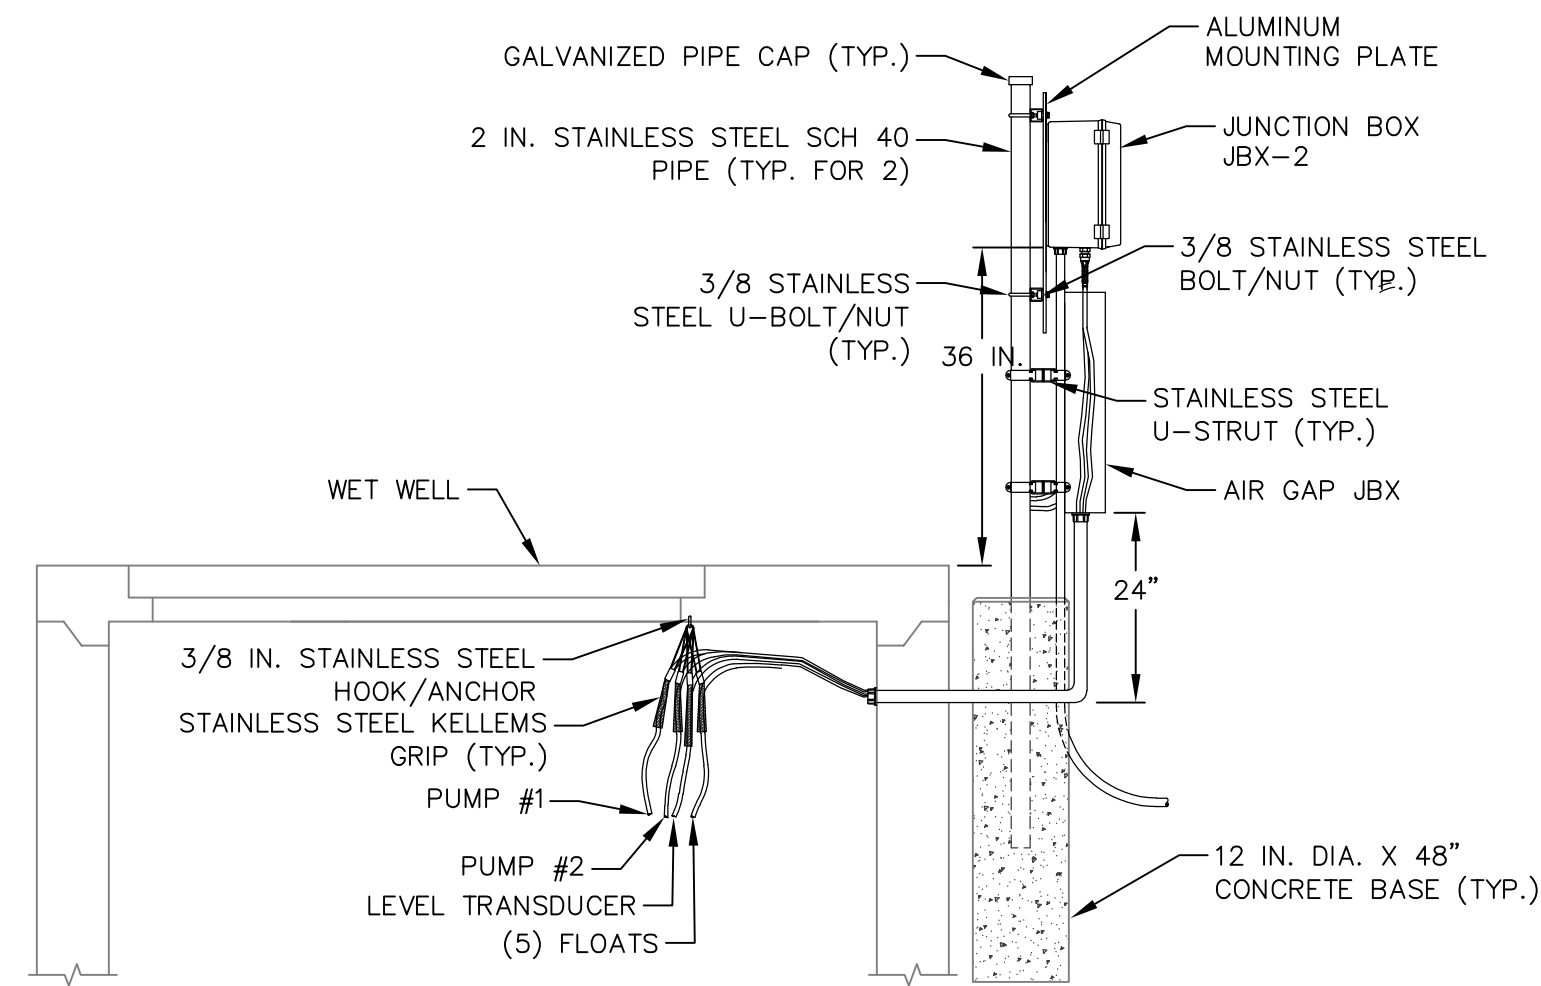
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Project
PHASE II - 133 PUMP STATION
FAIRFIELD COUNTY BROOKFIELD CONNECTICUT


Drawing Title
ELECTRICAL INTERCONNECT, AND DETAILS

Project No. 190093201
Date 8/28/2024
Drawn By TOS
Checked By HRS


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Sheet 6 of 7




WET WELL
AIR GAP ENCLOSURE DETAIL (SIDE VIEW)
NOT TO SCALE

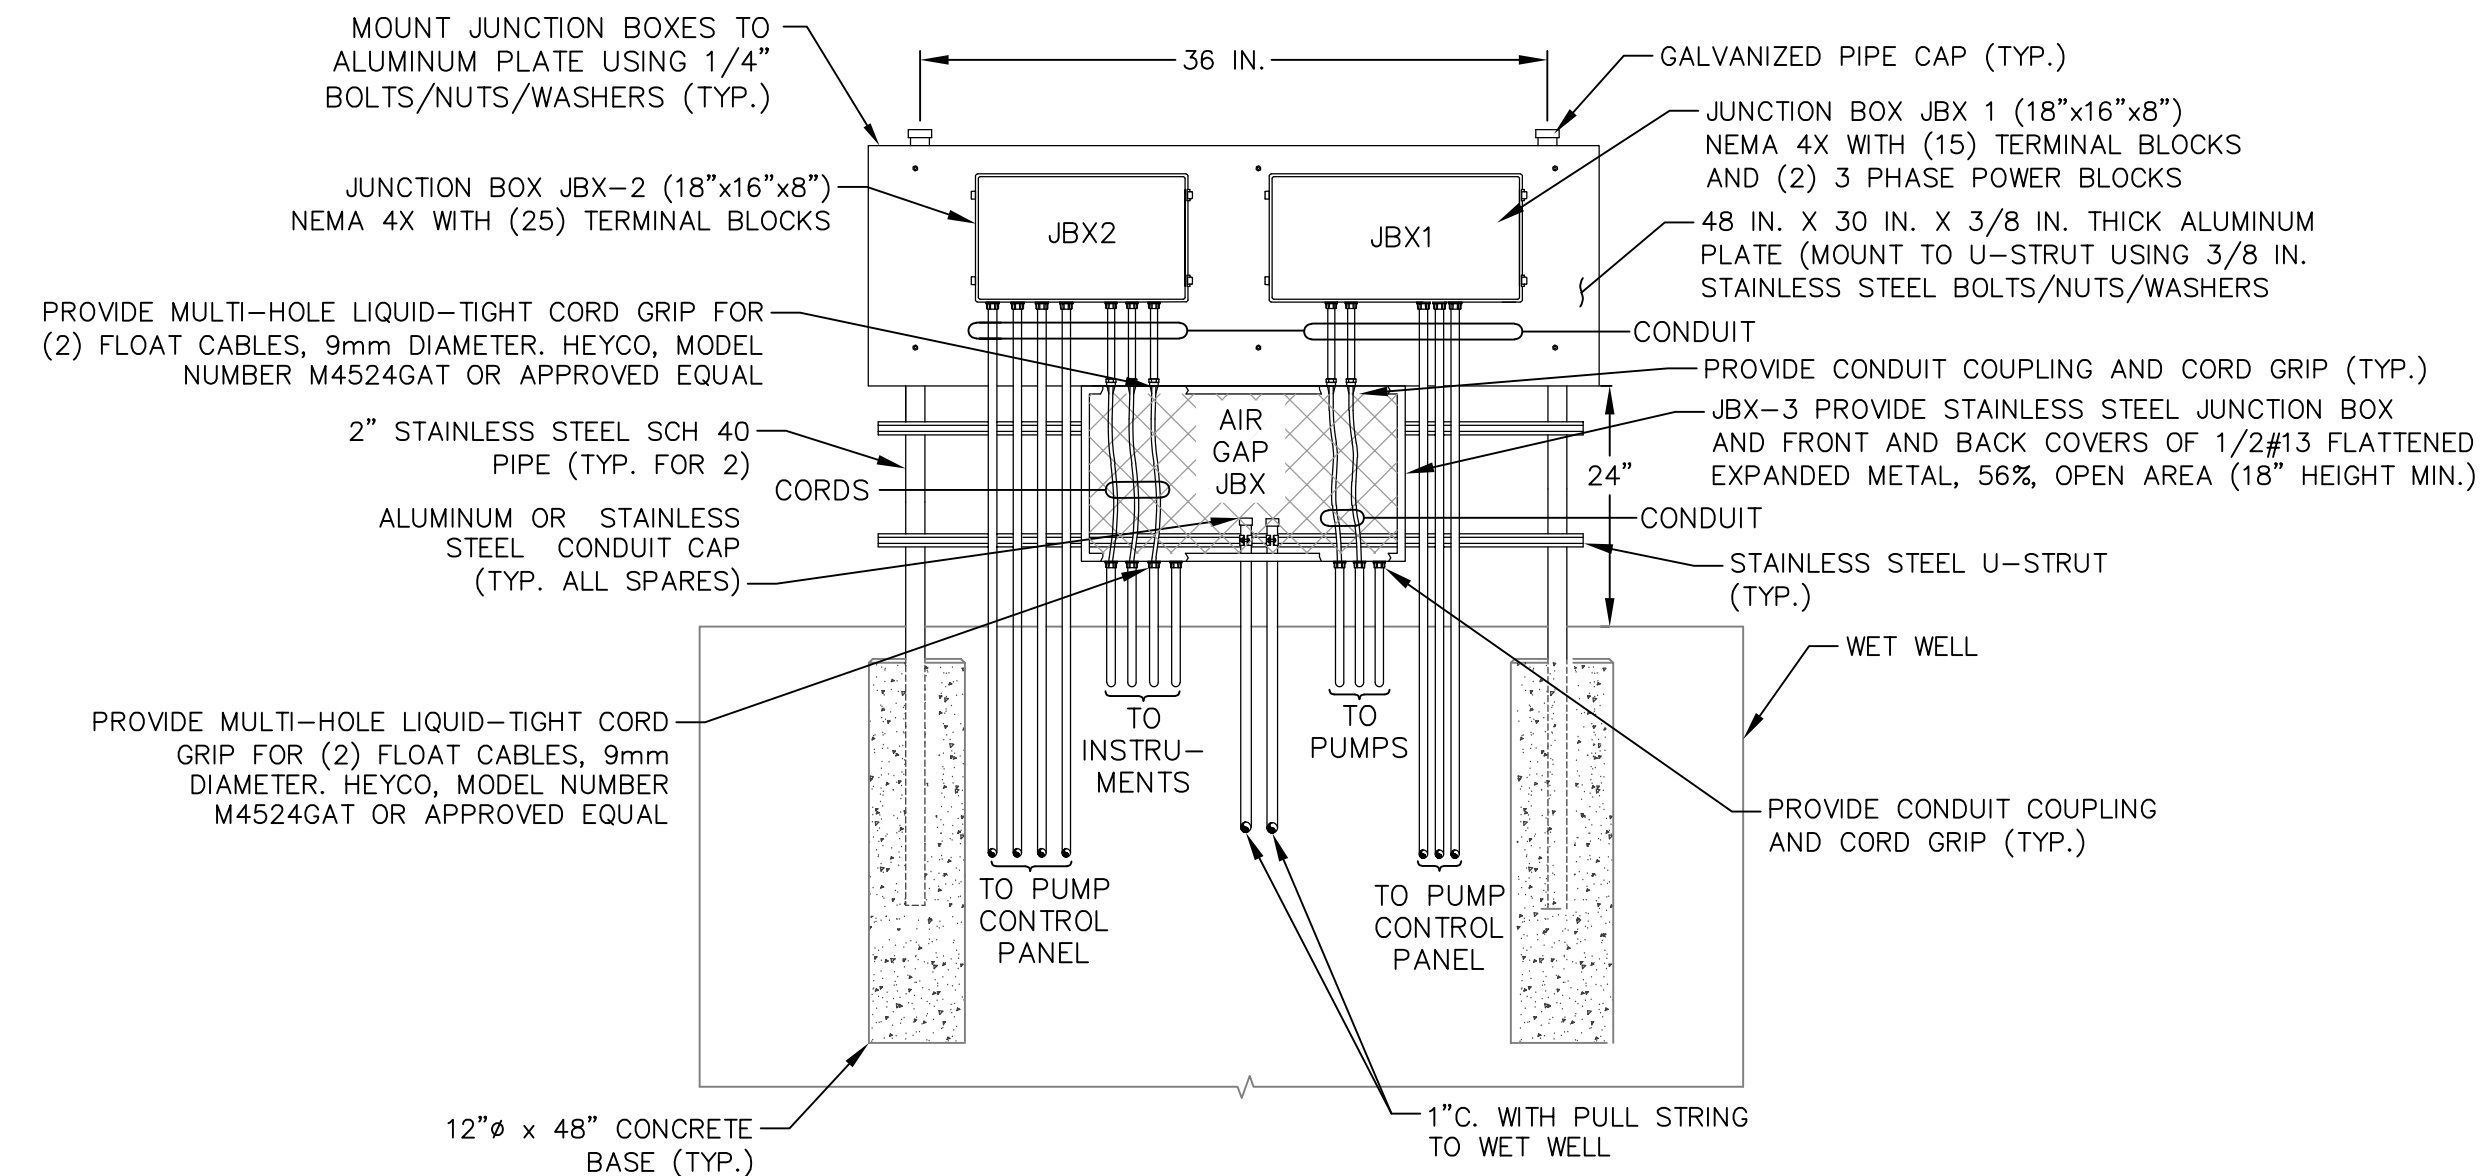

WET WELL
AIR GAP ENCLOSURE DETAIL (FRONT VIEW)
NOT TO SCALE

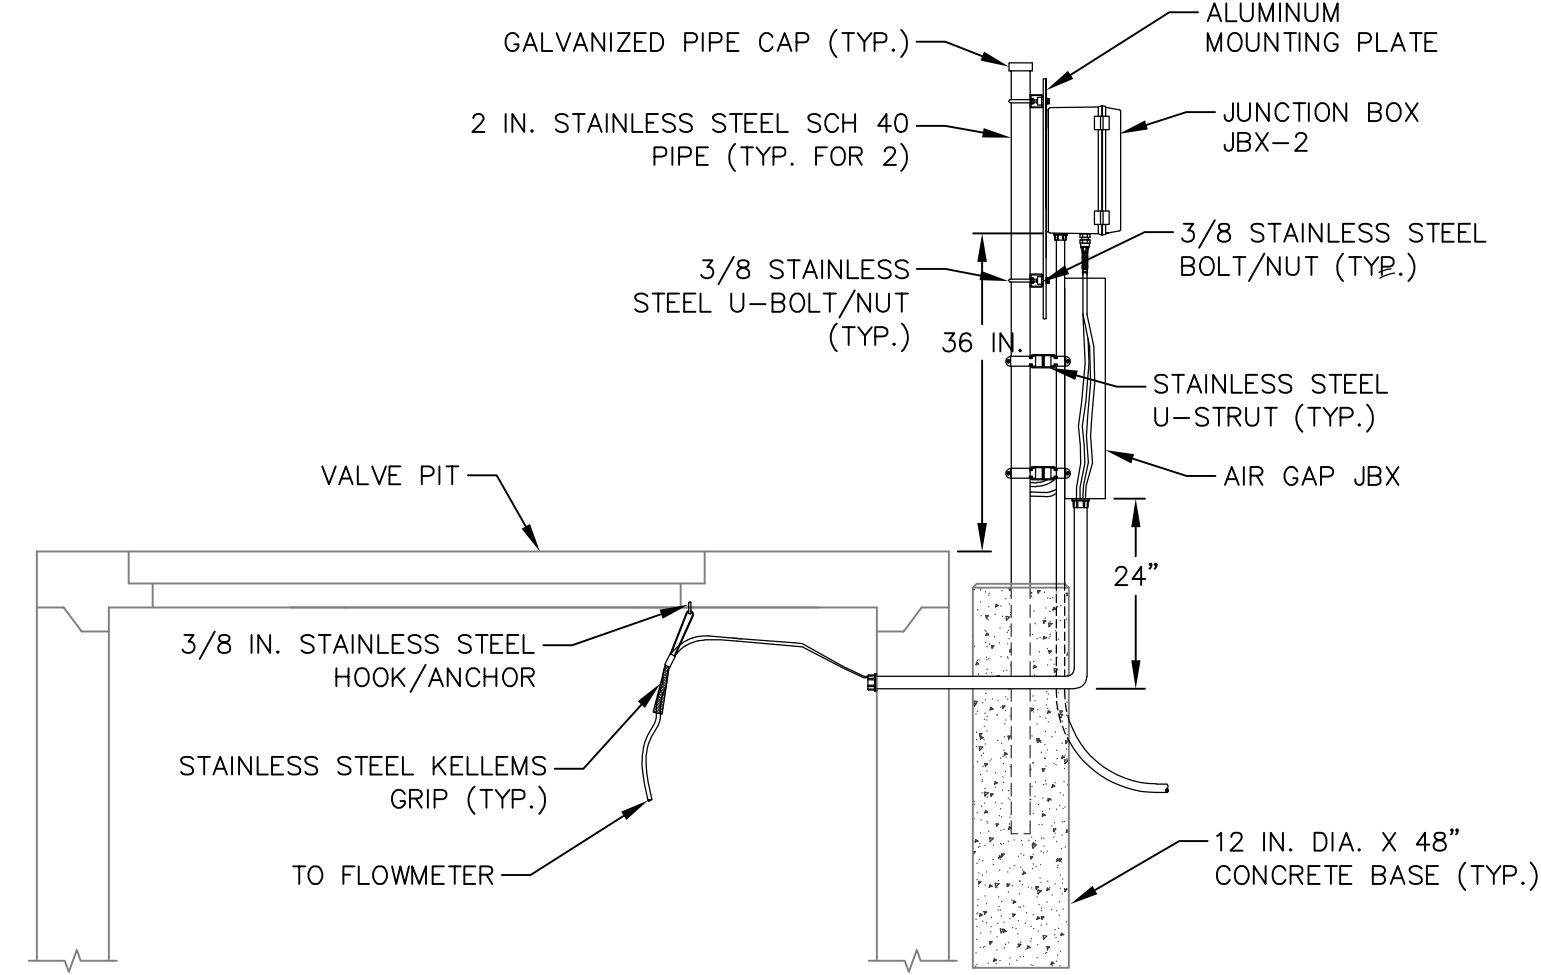

VALVE PIT
AIR GAP ENCLOSURE DETAIL (SIDE VIEW)
NOT TO SCALE

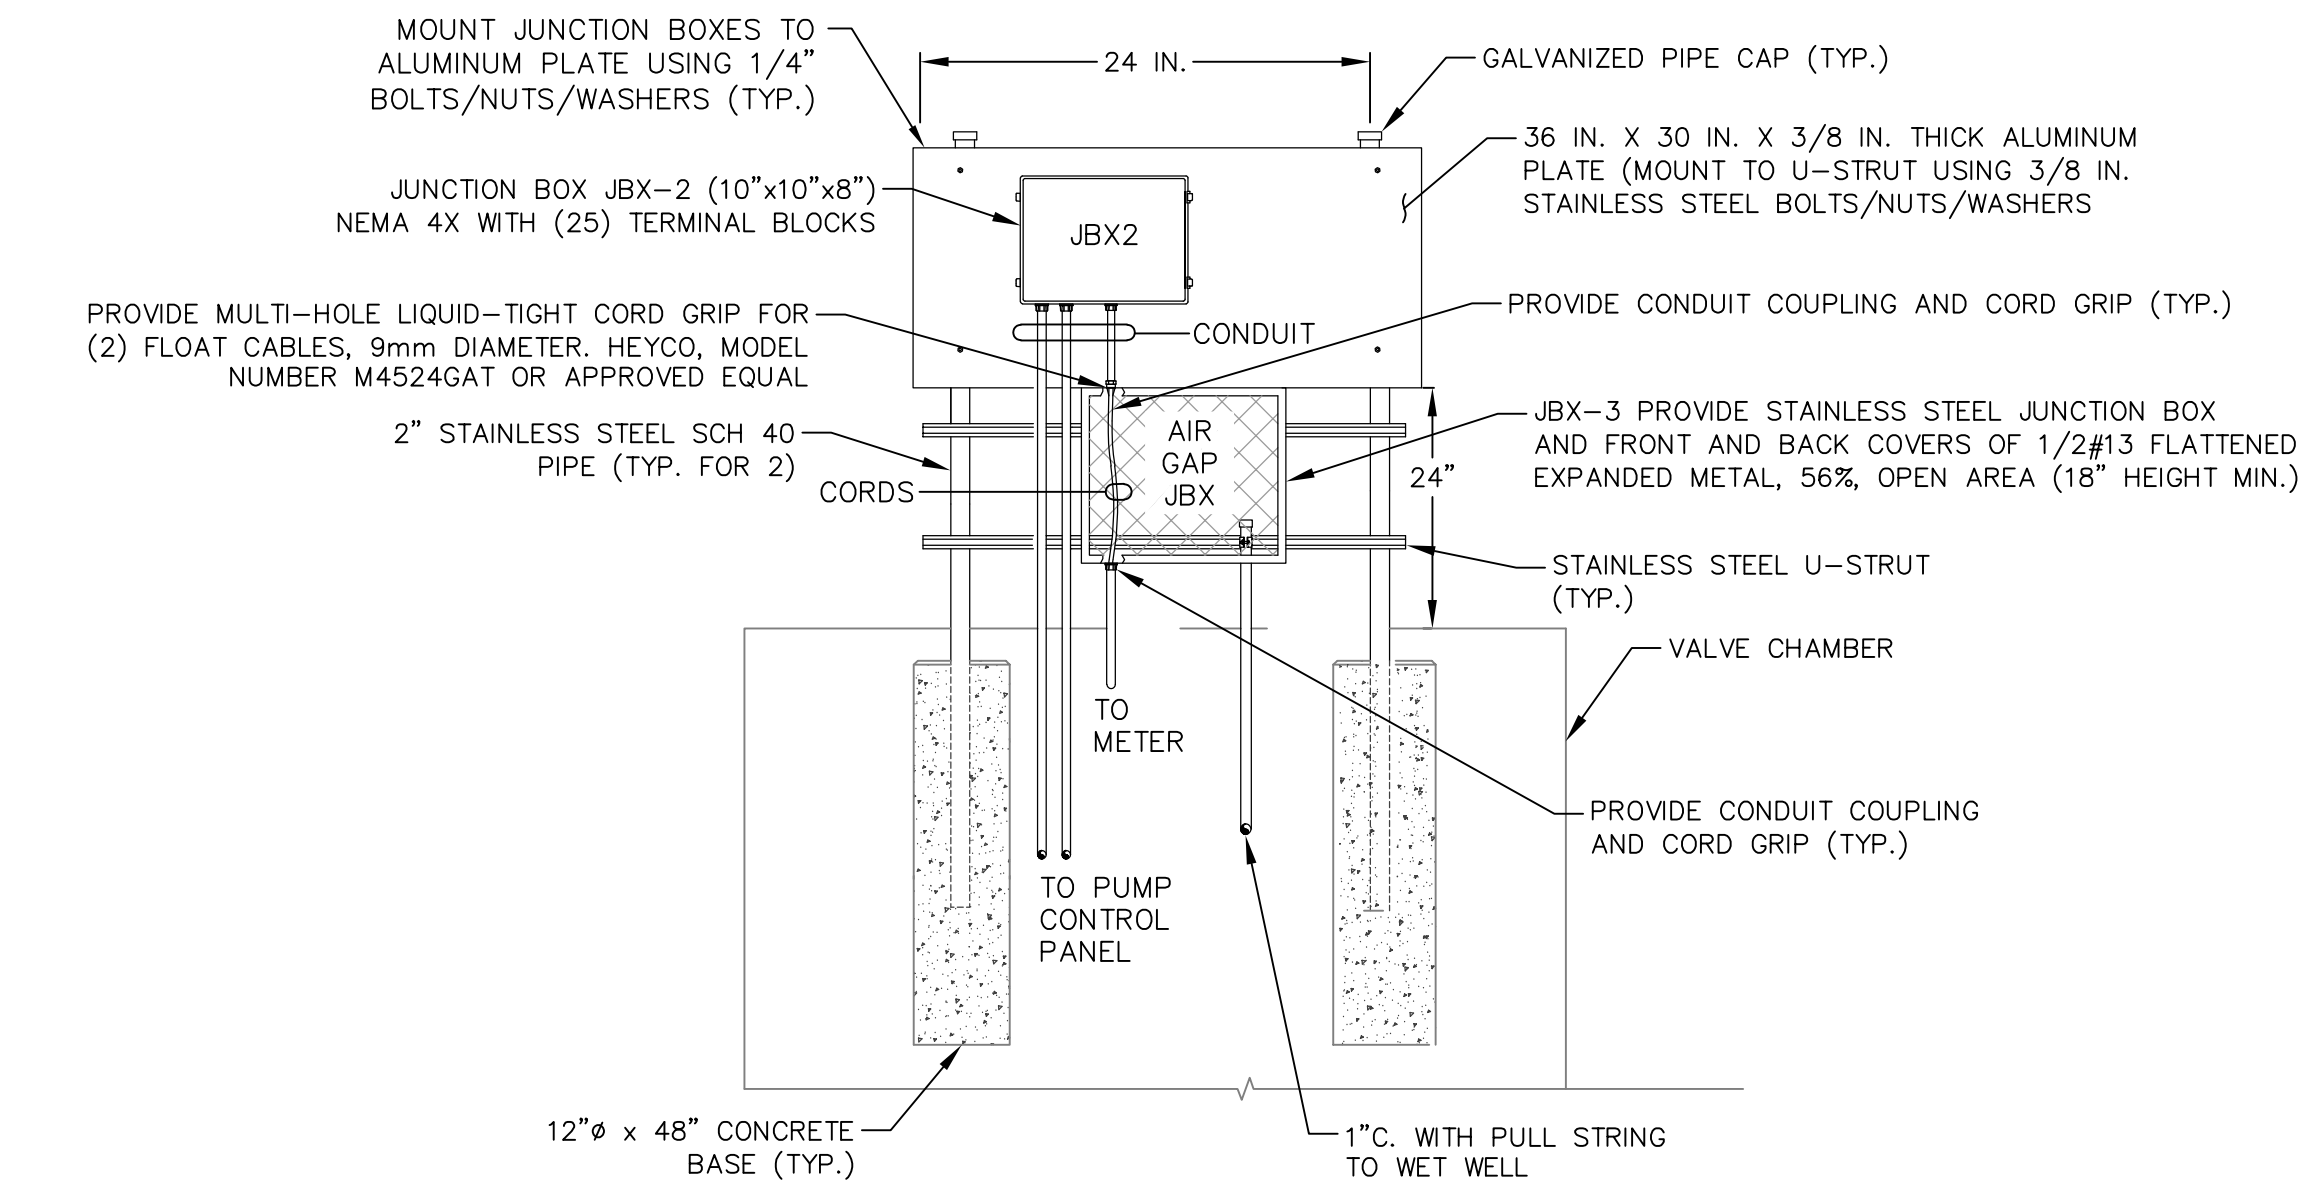

VALVE PIT
AIR GAP ENCLOSURE DETAIL (FRONT VIEW)
NOT TO SCALE

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Date	Description	No.
Revisions		

STATE OF CONNECTICUT
WILLIAM F. BLEILER
33415
LICENSED PROFESSIONAL ENGINEER
8/28/24

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Project
PHASE II - 133
PUMP STATION

FAIRFIELD COUNTY BROOKFIELD CONNECTICUT

Drawing Title
ELECTRICAL
DETAILS

Project No.
190093201

Date
8/28/2024

Drawn By
TOS

Checked By
HRS

E-603

Sheet 7 of 7

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Owner


BROOKFIELD WPCA
 53A COMMERCE ROAD, UNIT 1
 BROOKFIELD, CT 06804

Project

**133 PUMP STATION
 TOWN OF BROOKFIELD
 CONNECTICUT**

Contractor

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No.	Date	Revision/Issue
—	—	—

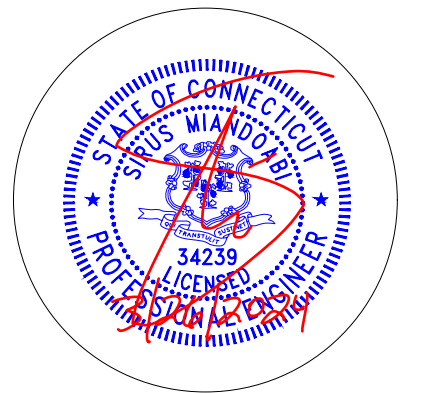Drawn By SM

Checked By

Sheet Title

GENERAL NOTES

Project # 240101

Sheet

Date 03/18/2024

S-001

Scale N.T.S.

GENERAL NOTES:

- NOTES, TYPICAL DETAILS AND SCHEDULES APPLY TO ALL STRUCTURAL WORK UNLESS OTHERWISE NOTED. FOR CONDITIONS NOT SPECIFICALLY SHOWN, PROVIDE DETAILS OF A SIMILARLY NATURE, VERIFY APPLICABILITY BY SUBMITTING SHOP DRAWINGS FOR REVIEW.
- STRUCTURAL DRAWINGS SHALL BE USED IN CONJUNCTION WITH THE SPECIFICATIONS, SITE CIVIL, AND MECHANICAL DRAWINGS. IF THERE IS A DISCREPANCY BETWEEN DRAWINGS IT IS THE CONTRACTOR'S RESPONSIBILITY TO NOTIFY THE ENGINEER PRIOR TO PERFORMING WORK.
- DO NOT SCALE DRAWINGS TO OBTAIN DIMENSIONAL INFORMATION.
- SEE ARCHITECTURAL DRAWINGS FOR WATER/DAMP-PROOFING AND FIRE-PROOFING DETAILS AND REQUIREMENTS.
- THESE DRAWINGS DO NOT DEFINE SCOPE OF CONTRACTS.
- AT ALL TIMES THE CONTRACTOR SHALL BE SOLELY RESPONSIBLE FOR THE CONDITIONS OF THE JOBSITE, INCLUDING SAFETY OF PERSONS AND PROPERTY. THE ARCHITECT'S OR ENGINEER'S PRESENCE OR REVIEW OF WORK DOES NOT INCLUDE THE ADEQUACY OF THE CONTRACTOR'S MEANS OR METHODS OF CONSTRUCTION.
- SHORING, BRACING AND PROTECTION OF EXISTING AND ADJACENT STRUCTURES DURING CONSTRUCTION IS THE SOLE RESPONSIBILITY OF THE CONTRACTOR. PROTECT AND MAINTAIN THE INTEGRITY OF ADJACENT STREETS, BUILDINGS AND STRUCTURES.
- ALL EXISTING DIMENSIONS AND LOCATIONS OF EXISTING STRUCTURES ON DRAWINGS SHALL BE VERIFIED BY FIELD MEASUREMENTS. ANY DISCREPANCIES SHALL BE REPORTED TO THE ENGINEER.
- DRAWINGS HAVE BEEN PREPARED BASED ON AVAILABLE KNOWLEDGE OF EXISTING CONDITIONS. IF, DURING DEMOLITION, EXCAVATION, OR CONSTRUCTION ACTUAL CONDITIONS ARE DISCOVERED TO DIFFER FROM THOSE INDICATED ON DRAWINGS, ENGINEER SHALL BE NOTIFIED IMMEDIATELY.

FOUNDATION NOTES:

- WALL FOOTINGS SHALL BEAR ON SOIL WITH A MINIMUM BEARING CAPACITY OF 1 TSF, SUBJECT FIELD VERIFICATION
- FOOTINGS SHALL BEAR ON FIRM, UNDISTURBED SOIL AT A MINIMUM OF 3'-6" BELOW FINISHED GRADE. ALL FOOTINGS SHALL BE FORMED.
- PROVIDE DOWELS IN FOUNDATIONS FOR ALL WALLS, COLUMNS, AND SHEAR WALLS OF SAME NUMBER AND SIZE AS THE VERTICAL REINFORCEMENT ABOVE, U.O.N.
- PROVIDE WATER STOPS IN ALL VERTICAL CONSTRUCTION JOINTS.
- SLABS ON GRADE SHALL BE PLACED ON SELECT FILL COMPACTED TO 90 PERCENT MODIFIED PROCTOR MAXIMUM DRY DENSITY (ASTM D1557) AND HAVE A VAPOR BARRIER OF 6MIL POLYETHYLENE FILM WITH EDGES LAPPED 6" OVER A 4" GRAVEL BED.
- FOUNDATION WALLS SHALL BE FORMED TO PRODUCE A SMOOTH AND UNIFORM FINISH.

CONCRETE NOTES:

- CONCRETE WORK SHALL CONFORM TO ACI-318. IN CASE OF CONFLICT, THE NEW YORK STATE BUILDING CODE SHALL TAKE PRECEDENCE
- ALL FOOTINGS FOUNDATION WALLS, FRAMED SLABS SHALL BE CONTROLLED AIR ENTRAINED CONCRETE HAVING A MINIMUM ULTIMATE COMPRESSIVE STRENGTH OF 5000-PSI IN 28 DAYS, ASTM TYPE 1 WITH 4" SLUMP, AND HAVE PROPERTIES TO RESIST SEVER WEATHERING POTENTIAL.
- ALL REINFORCING SHALL BE A MINIMUM OF GRADE 60
- ALL DOWELS TO BE HOT-DIP GALVANIZED WITH NUT AND WASHER TO FIT ALONG TOP OF FOUNDATION WHERE SILL PLATES ARE TO BE ANCHORED, EXTEND 16" INTO CONCRETE BELOW, AND WITH HOOKS MINIMUM OF 4"
- REINFORCING CONCRETE SHALL HAVE A MINIMUM CLEAR COVER AS FOLLOWS:
 - CONCRETE POURED AGAINST EARTH - 3"
 - CONCRETE EXPOSED TO EARTH OR WEATHER
 - #5 OR SMALLER - 1½"
 - #6 OR LARGER - 2"
 - CONCRETE NOT EXPOSED TO WEATHER OR IN CONTRACT WITH GROUND
 - COLUMNS (TIES & MAIN REINFORCING) - 1½"
 - SLABS, WALLS, JOISTS #14 OR #18 BARS - 1½"
 - #11 OR SMALLER - ¾"
 - BEAMS (STIRRUPS AND MAIN REINFORCING) - 1½"
 - CLEAR COVER SHALL BE CLEARLY SHOWN ON ALL REBAR DETAIL DRAWINGS
- ALL REINFORCING SHALL BE SECURELY HELD IN POSITION WHILE PLACING CONCRETE. IF NECESSARY, ADDITIONAL BARS SHALL BE PROVIDED BY THE CONTRACTOR TO FURNISH SUPPORT
- THE CONTRACTOR SHALL VERIFY THE DIMENSIONS AND LOCATIONS OF ALL OPENINGS, IF NECESSARY. OPENINGS NOT SHOWN ON THE STRUCTURAL DRAWINGS SHALL BE INSTALLED ONLY AFTER APPROVAL BY THE STRUCTURAL ENGINEER IS OBTAINED.
- LOCATION OF ALL CONSTRUCTION JOINTS NOT SHOWN ON DRAWINGS SHALL BE SUBMITTED TO ENGINEER FOR APPROVAL PRIOR TO DETAILING OF REINFORCING. ALL CONSTRUCTION JOINTS TO BE CLEARLY SHOWN ON REBAR DETAIL DRAWINGS. ENGINEER MAY REQUIRE ADDITIONAL REINFORCING AT CONSTRUCTION JOINTS.
- COLD WEATHER CONCRETE CONSTRUCTION SHALL BE IN COMPLIANCE WITH ACI 318.

BACK-FILL GENERAL NOTES:

- ONLY GRANULAR SOILS TO BE USED FOR BACK-FILL
- VIBRATORY PLATE HAMMER TO BE USED IN 6-8" LIFTS, BUT NO MORE THAN 10".
- MOISTURE CONTENT OF SOIL TO BE MONITORED PRIOR TO COMPACTION (OPTIMAL MOISTURE CONTENT= 11%)
- 90% OF DRY DENSITY COMPACTION RECOMMENDED
- SEE FOUNDATION NOTES FOR ADDITIONAL INFORMATION.

WOOD FRAMING NOTES:

- ALL WOOD TO BE DF-L NO. 1 OR EQ/GREATER, U.O.N.
- ALL CONSTRUCTION SHALL BE IN ACCORDANCE WITH THE 2020 NYS RESIDENTIAL BUILDING CODE
- ALL CONNECTIONS TO BE MADE PER MANUFACTURER'S INSTRUCTIONS, RECOMMENDATIONS AND FASTENING REQUIREMENTS.
- LVL'S SHALL HAVE A MINIMUM OF 2 ROWS OF 16D NAILS 12" OC FOR BEAMS LESS THAN 12", 3 ROWS FOR GREATER THAN 12"
- APPROPRIATE SIMPSON STRONG-TIE CONNECTORS TO BE INSTALLED AND USED FOR THEIR INTENDED PURPOSE
- HURRICANE TIES TO BE MIN 18-GA LTS
- COLUMNS CAPS TO BE CC/ECC/ECCU U.O.N.
- TOP FLANGE JOIST HANGERS JB/JBA TO BE USED FOR ALL ASYMMETRIC LOADED BEAMS, FACE MOUNTED JOIST HANGERS LU28/LUS28 TO BE USED FOR SYMMETRIC LOADED BEAMS ONLY.
- ALL IN-WALL POSTS TO BE CONTINUOUSLY BRACED TO SHEATHING WHERE AVAILABLE.
- ALL WOOD EXPOSED TO WEATHER SHALL BE PRESSURE TREATED KILN-DRIED AND PAINTED. IF WOOD IS NOT KILN-DRIED, ALLOW 2-4 MONTHS TO DRY AND THEN PAINT. PAINT SHALL BE EXTERIOR GRADE AND APPLIED WITH PRIMER OR PER MANUFACTURERS INSTRUCTIONS (MINIMUM 2 COATS)

STEEL FRAMING NOTES:

- ALL NEW STEEL (INCLUDING THE STEEL USED IN CONNECTIONS) SHALL CONFORM TO THE FOLLOWING ASTM SPECIFICATIONS UNLESS SPECIFICALLY INDICATED OTHERWISE ON THE DRAWINGS:
 - STEEL: W-SECTIONS SHALL BE STANDARD A992, GRADE 50, WITH A MINIMUM YIELD STRENGTH OF 50 KSI. PLATES AND ANGLES SHALL BE STANDARD A36, WITH A MINIMUM YIELD STRENGTH OF 36 KSI. HSS SHALL BE STANDARD A500 Gr.B.
 - BOLTS: 3/4" MINIMUM, ASTM A325 N BEARING TYPE BOLTS UNLESS OTHERWISE NOTED
- ALL STRUCTURAL STEEL WORK SHALL CONFIRM TO THE FOLLOWING GOVERNING STANDARDS:
 - AISC "SPECIFICATION FOR STRUCTURAL STEEL BUILDINGS", LATEST EDITION
 - THE AMERICAN WELDING SOCIETY (AWS D1.1) "STRUCTURAL WELDING CODE - STEEL", LATEST EDITION
- STEEL CONNECTIONS SHALL BE STANDARD AISC FRAMED BM CONNECTIONS UNLESS NOTED OTHERWISE
- SHOP AND FIELD CONNECTIONS NOT SPECIFICALLY DETAILED ON THE DRAWINGS MAY BE BOLTED OR WELDED
- ALL WELDING SHALL BE PERFORMED BY QUALIFIED WELDING IN ACCORDANCE WITH AWS SPECIFICATIONS, LATEST EDITION. ALL WELDING ELECTRODES SHALL CONFORM TO AWS A5.1 GRADE E-70XX. BARE ELECTRODES AND GRANULAR FLUX SHALL CONFORM TO A.W.S. A5.17, F70 A.W.S. FLUX CLASSIFICATION (USE LOW HYDROGEN ELECTRODES FOR A572, GRADE 50 STEEL).
- ALL WELDS NOT SPECIFICALLY CALLED OUT SHALL BE AT LEAST THE MINIMUM WELD SIZE AS SPECIFIED BY THE AISC MANUAL OF STEEL DESIGN, LATEST EDITION.
- ALL FIELD SPLICES AND CONNECTIONS SHALL BE WELDED OR BOLTED USING HIGH STRENGTH BOLTS.
- SPLICES SHALL BE DESIGNED TO DEVELOP THE FULL CAPACITY OF THE MEMBER AT THE POINT OF SPlice UNLESS OTHERWISE NOTED. MEMBERS SHALL NOT BE SPLICED AT THE POINTS OF MAXIMUM STRESS.
- ALTERNATE CONNECTION DETAILS MAY BE USED IF SUCH DETAILS ARE SUBMITTED TO THE ENGINEER FOR REVIEW AND ACCEPTANCE IS GRANTED. HOWEVER, THE ENGINEER SHALL BE THE SOLE JUDGE OF ACCEPTABILITY AND THE CONTRACTOR'S BID SHALL INCLUDE THE COST OF THOSE SPECIFIC DETAILS SHOWN ON THE DRAWINGS. IN ANY EVENT, THE CONTRACTOR SHALL BE RESPONSIBLE FOR THE DESIGN OF SUCH ALTERNATE CONNECTION DETAILS WHICH THEY PROPOSE. ANY ALTERNATE DETAIL SUBMITTED BY THE CONTRACTOR SHALL BE SIGNED AND SEALED BY A PROFESSIONAL ENGINEER LICENSED IN THE STATE OF NEW YORK.
- CUTS, HOLES, COPIES, ETC. REQUIRED FOR WORK OF OTHER TRADES IF ANY SHALL BE APPROVED BY THE ENGINEER AND SHALL BE SHOWN ON THE SHOP DRAWINGS AND MADE IN THE SHOP. CUTS OR BURNING OF HOLES IN STRUCTURAL STEEL MEMBERS IN THE FIELD WILL NOT BE PERMITTED
- ALL BMS SHALL BE FABRICATED WITH NATURAL CAMBER UP.
- STRUCTURAL DRAWINGS SHALL BE USED IN CONJUNCTION WITH ARCHITECTURAL AND MECHANICAL DRAWINGS AND DRAWINGS RELATED TO OTHER TRADES (IF ANY). THE CONTRACTOR SHALL BE RESPONSIBLE FOR CHECKING AND COORDINATING DIMENSIONS, CLEARANCES, ETC. WITH THE WORK OF OTHER TRADES.
- THE CONTRACTOR SHALL COORDINATE ALL MISCELLANEOUS STEEL DETAILING REQUIREMENTS SHOWN ON THE ARCHITECTURAL AND MECHANICAL DRAWINGS (IF ANY).
- SHOP AND ERECTION DRAWINGS SHALL BE SUBMITTED TO THE STRUCTURAL ENGINEER FOR REVIEW AND APPROVAL. NO FABRICATION OF STEEL SHALL COMMENCE WITHOUT APPROVED SHOP DRAWINGS.
- ALL NEW EXPOSED EXTERIOR STEEL SHALL BE PROTECTED AGAINST CORROSION. STRUCTURAL STEEL MEMBERS SHALL RECEIVE THREE (3) COATS OF CORROSION INHIBITING PAINT; ONE (1) SHOP APPLIED PRIMER COAT AND ON INTERMEDIATE COAT APPLIED AFTER ERECTION OF TNEMEC 135 CHEMBUILD AT 4.0-6.0 MILS DRY FILM THICKNESS. THE FINISH COAT SHALL BE TNEMEC V73 ENDURA SHIELD AT 2.0-3.0 MILS DRY FILM THICKNESS. PAINT SYSTEMS: TNEMEC, BENJAMIN MOORE COROTECH DTM, SHERWIN WILLIAMS PRO AKYLID, OR APPROVED EQUAL. DO NOT PAINT IN SHOP SURFACES WITHIN TWO (2) INCHES OF FIELD WELDS, CONTACT SURFACES OF HIGH-STRENGTH BOLTED FRICTION CONNECTIONS AND BEARING SURFACES. THE FINISH COAT'S COLOR SHALL BE COORDINATED WITH THE OWNER/ARCHITECT.


POWDER ACTUATED FASTENER (PAF) NOTES:

- USER SHALL BE TRAINED & CERTIFIED BY THE MANUFACTURER PRIOR TO USE. DO NOT USE IN EXPLOSIVE OR FLAMMABLE ATMOSPHERE.
- SPECIAL PRECAUTIONS MAY BE REQUIRED, INCLUDING BUT NOT LIMITED TO: CERTIFICATE OF FITNESS, MATERIAL STORAGE & HANDLING. PRIOR TO USE CONFIRM REQUIREMENTS FROM MUNICIPAL BUILDING & FIRE DEPARTMENT(S).
- CONTROLLED ACCESS AND SAFETY ZONES AND BARRIERS SHALL BE ESTABLISHED PRIOR TO USE OF PAF INSTALLATION DEVICE.
- ALL TOOLS SHALL BE CLEANED & MAINTAINED PER MANUFACTURER'S SPECIFIC INSTRUCTIONS. CHECK ALL TOOLS PRIOR TO EACH DAY'S USE.
- DO NOT LOAD TOOL UNLESS IT IS TO BE USED IMMEDIATELY. DO NOT LEAVE LOADED TOOL UNATTENDED.
- CHECK COLOR OF EACH POWER LOAD BEFORE INSERTING INTO THE TOOL CHAMBER. IN THE EVENT OF MISFIRE, HOLD THE TOOL FIRMLY AGAINST THE WORK SURFACE FOR A PERIOD OF THIRTY (30) SECONDS, THEN FOLLOW MANUFACTURER'S EXPLICIT INSTRUCTIONS IN THE OPERATORS MANUAL.
- PROPER DISPOSAL OF SPENT & UNSPENT CARTRIDGES REQUIRED TO PREVENT SAFETY & ENVIRONMENTAL HAZARDS.
- KEEP HANDS CLEAR OF BARREL END, NEVER POINT TOOL AT ANYONE.
- MIN ONE (1) PORTABLE FIRE EXTINGUISHER, MIN 2A RATING PROVIDED WHERE AMMUNITION IS STORED. NO SMOKING.

Owner
BROOKFIELD WPCA
 53A COMMERCE ROAD, UNIT 1
 BROOKFIELD, CT 06804

Project
**133 PUMP STATION
 TOWN OF BROOKFIELD
 CONNECTICUT**

Contractor
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No.	Date	Revision/Issue
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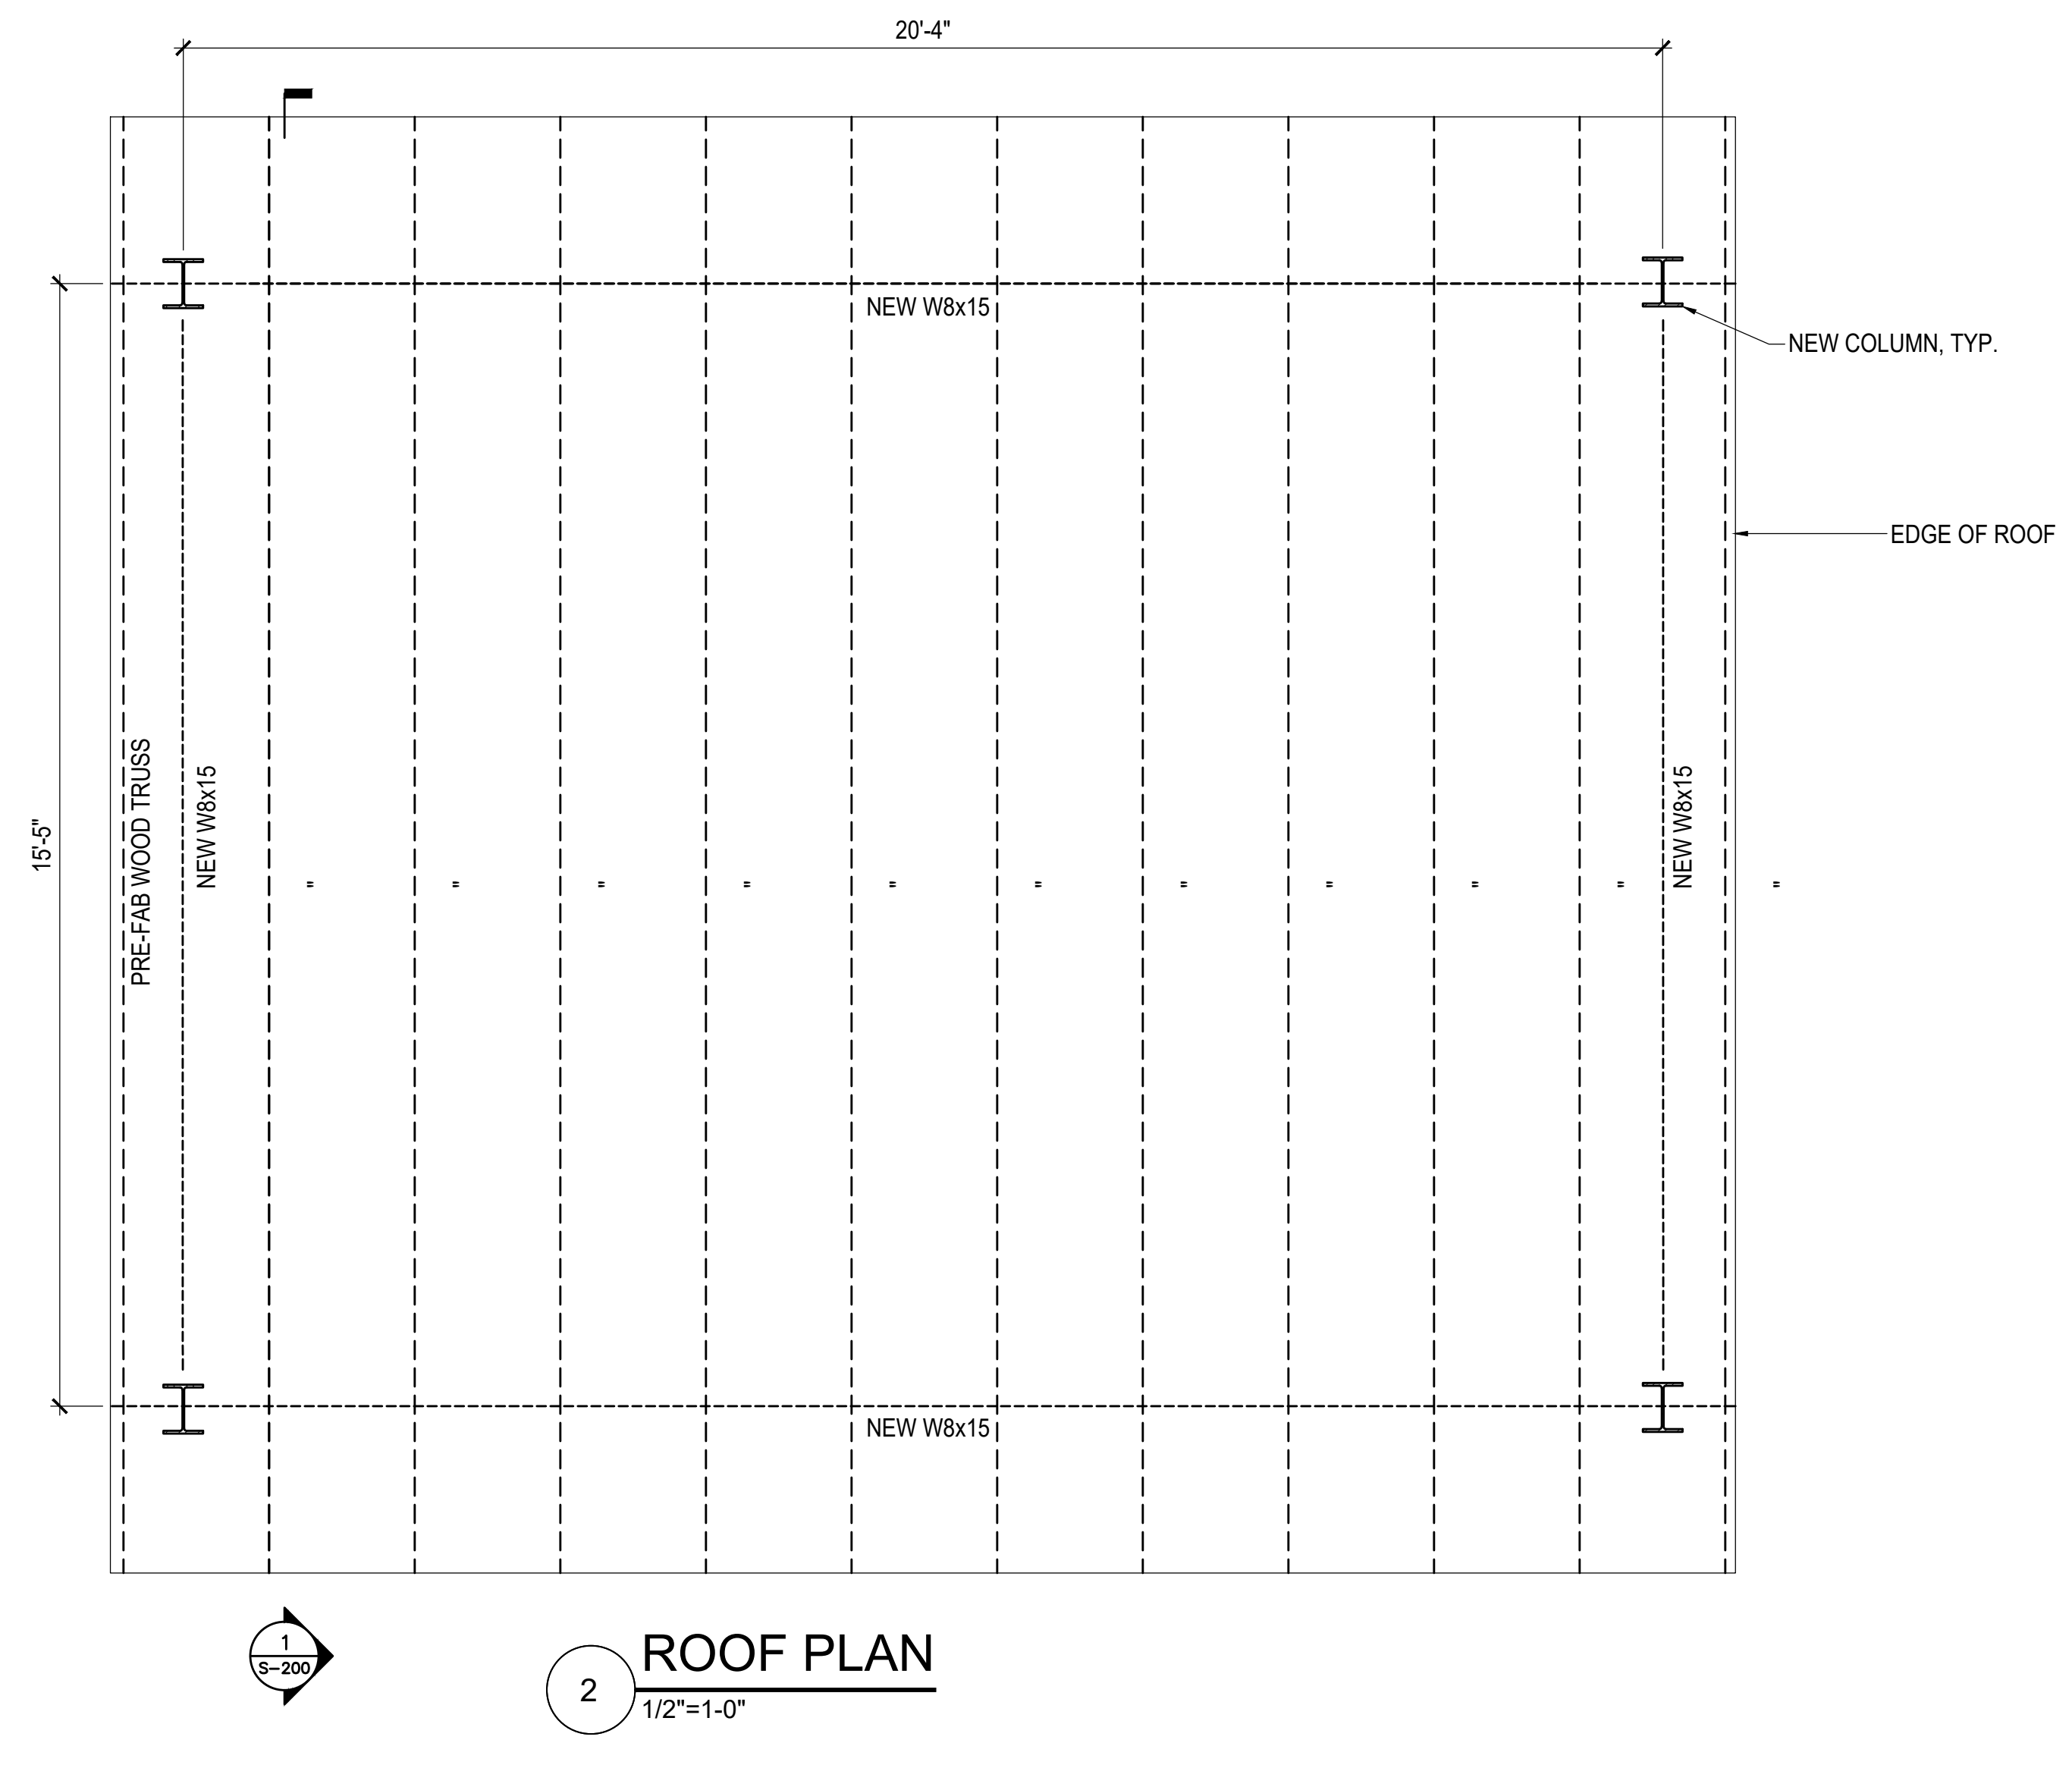
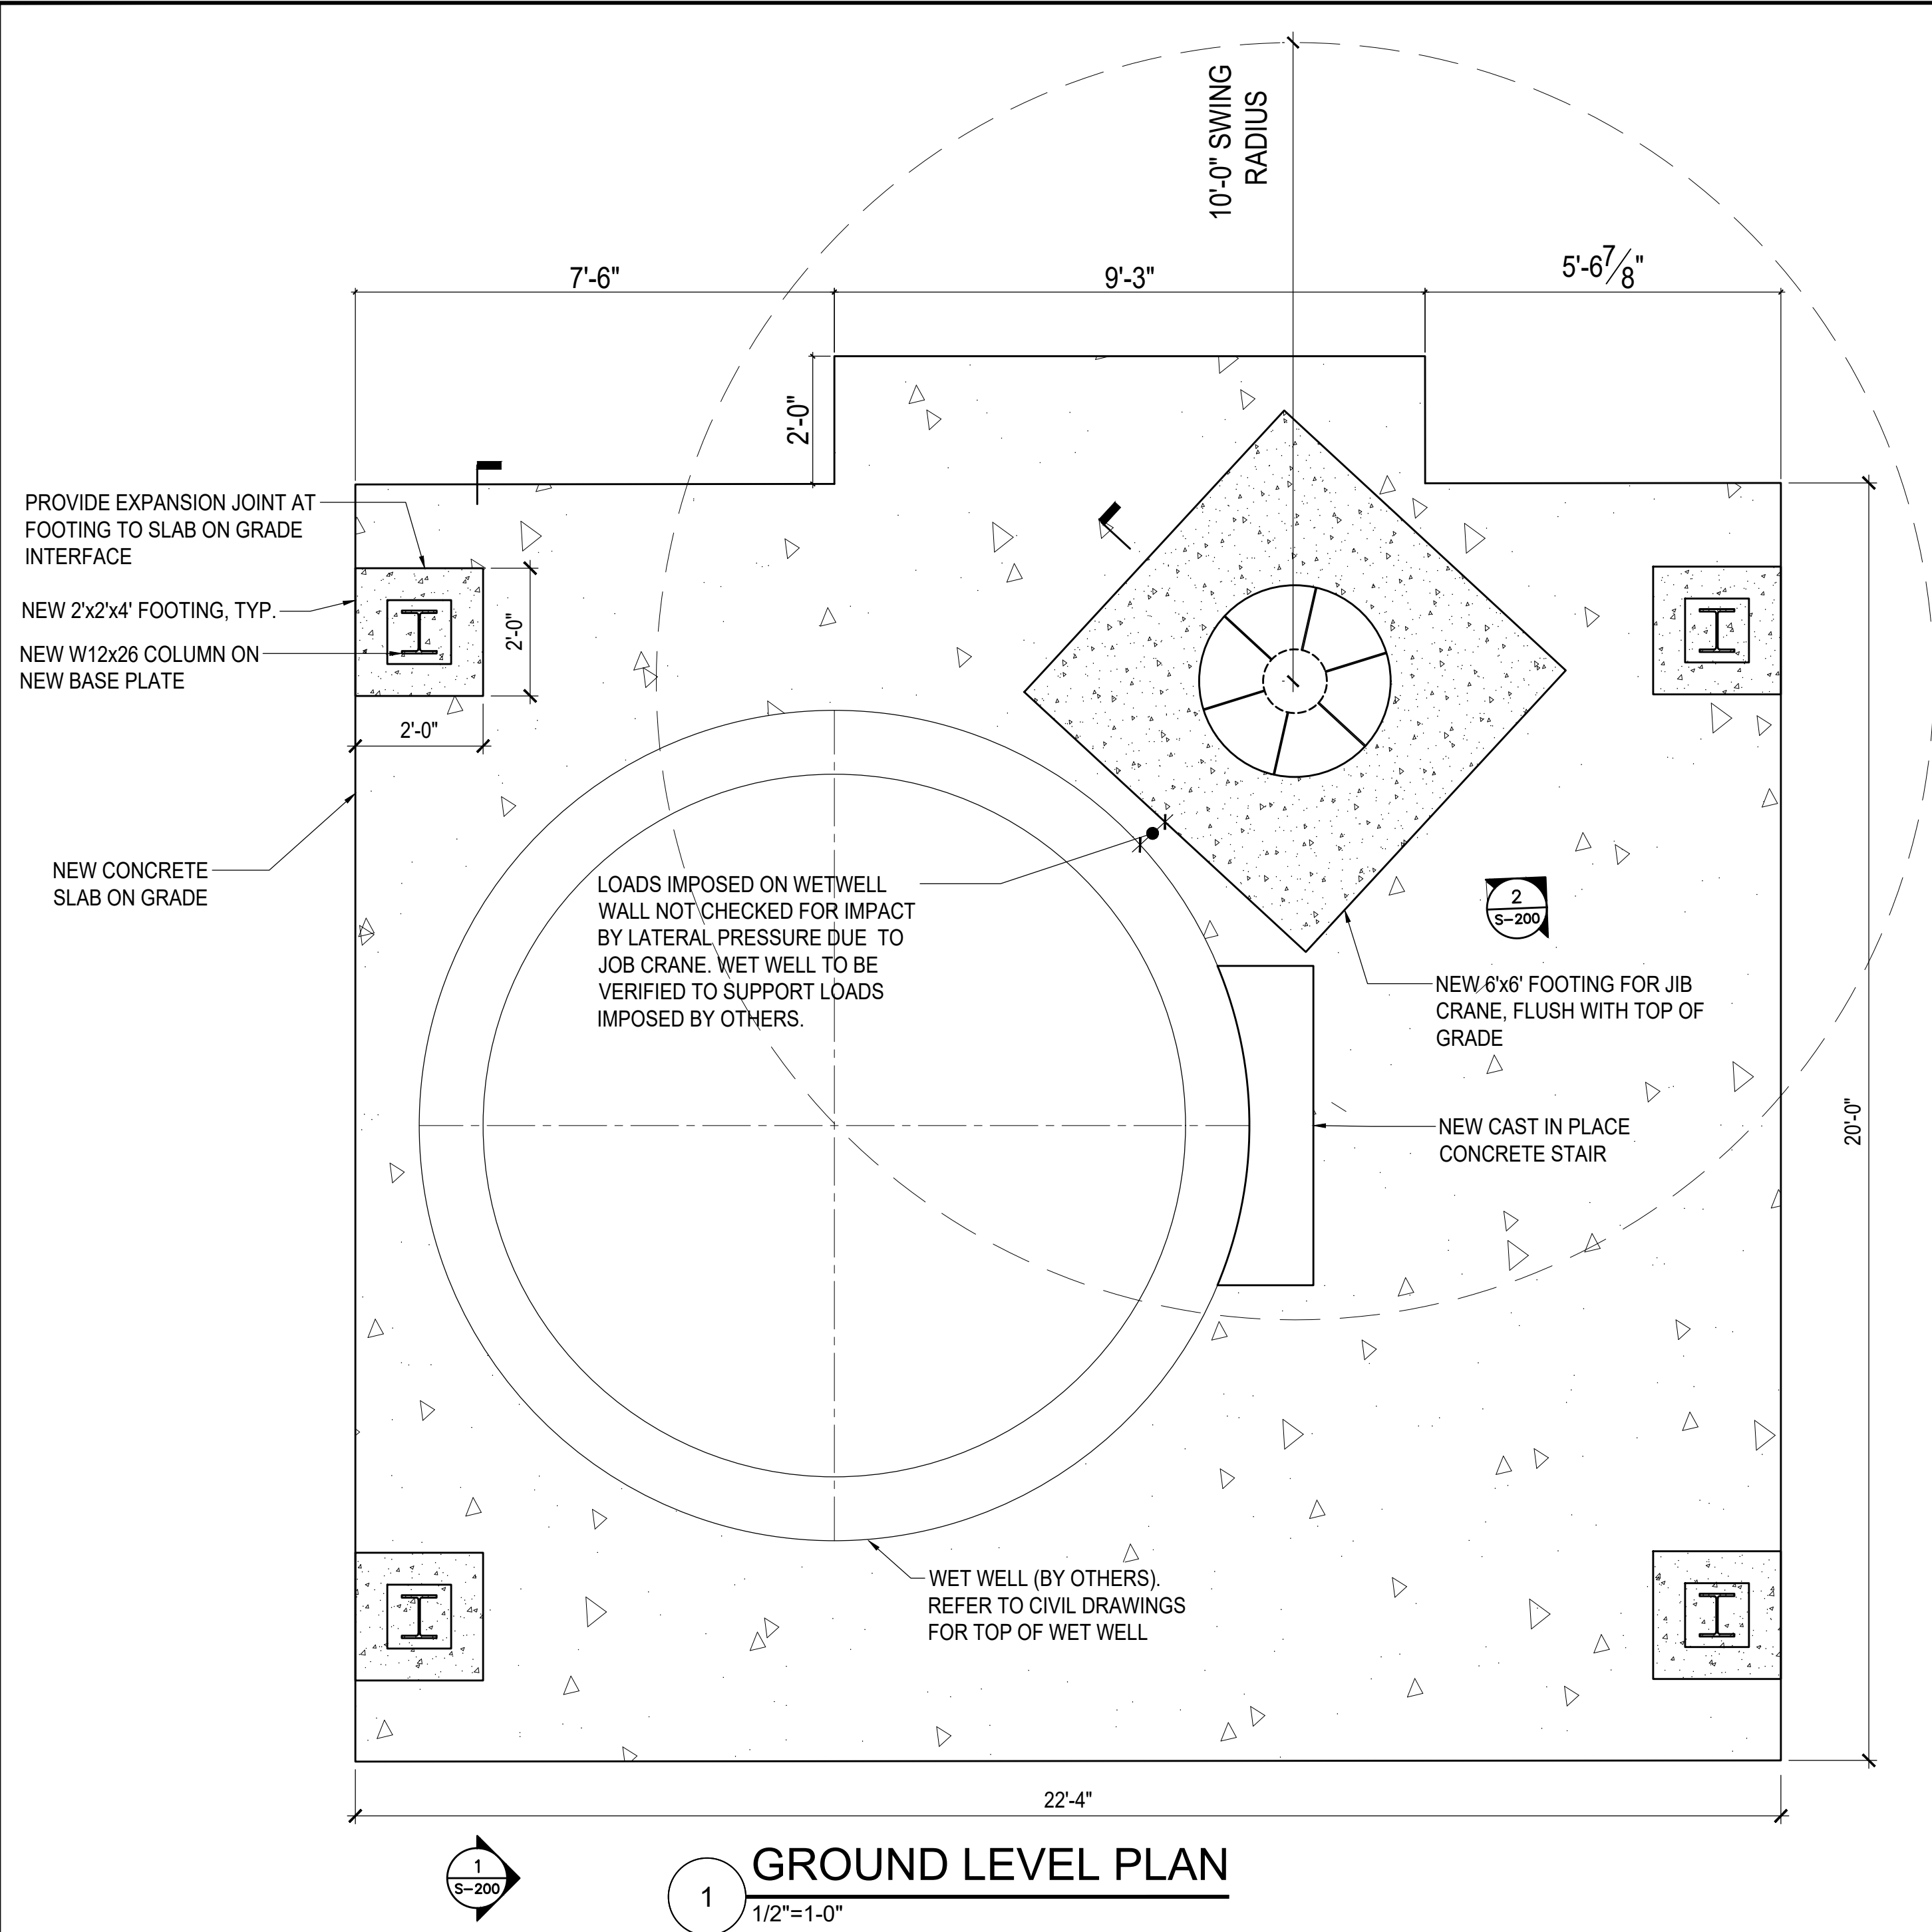
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Sheet Title

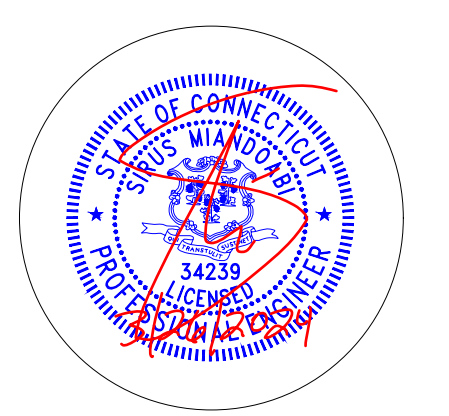PLANS

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Date 03/18/2024	S-100
Scale N.T.S.	




- NOTES:
- ALL STEEL SHALL BE PROTECTED AGAINST CORROSION. THE USE OF PROTECTIVE PAINT IS PERMITTED. ELSE ALL STEEL SHALL BE HOT DIPPED GALVANIZED TO ASTM A123.
 - ALL WOOD SHALL BE PRESSURE TREATED AND RATED FOR EXTERIOR USE.
 - EXPOSED WOOD TRUSS WOOD SHALL BE PAINTED TO PROTECT AGAINST CORROSION.
 - ALL CONCRETE FOOTINGS SHALL HAVE A MINIMUM $f_c=4,500$ PSI AND HAVE 6% AIR ENTRAINMENT.

Owner
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Sheet Title

SECTIONS & DETAILS


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Sheet

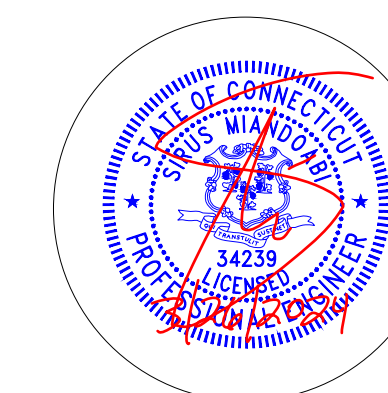Date 03/18/2024


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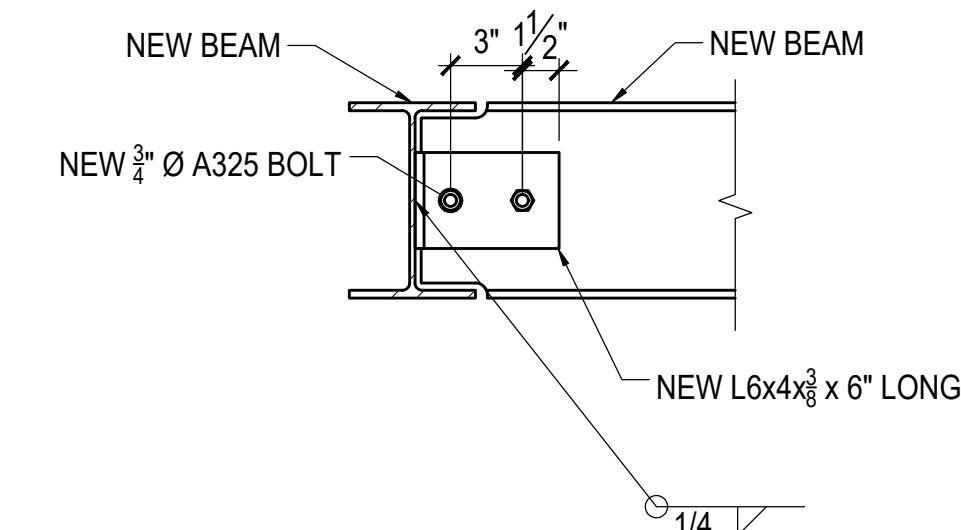
NOTE:
 1. PROJECT SPECIFIC SHOP DRAWINGS AND SUBMITTALS TO BE SUBMITTED FOR EOR APPROVAL PRIOR TO FABRICATION AND INSTALLATION.

1 SECTION
 3/8"=1'-0"

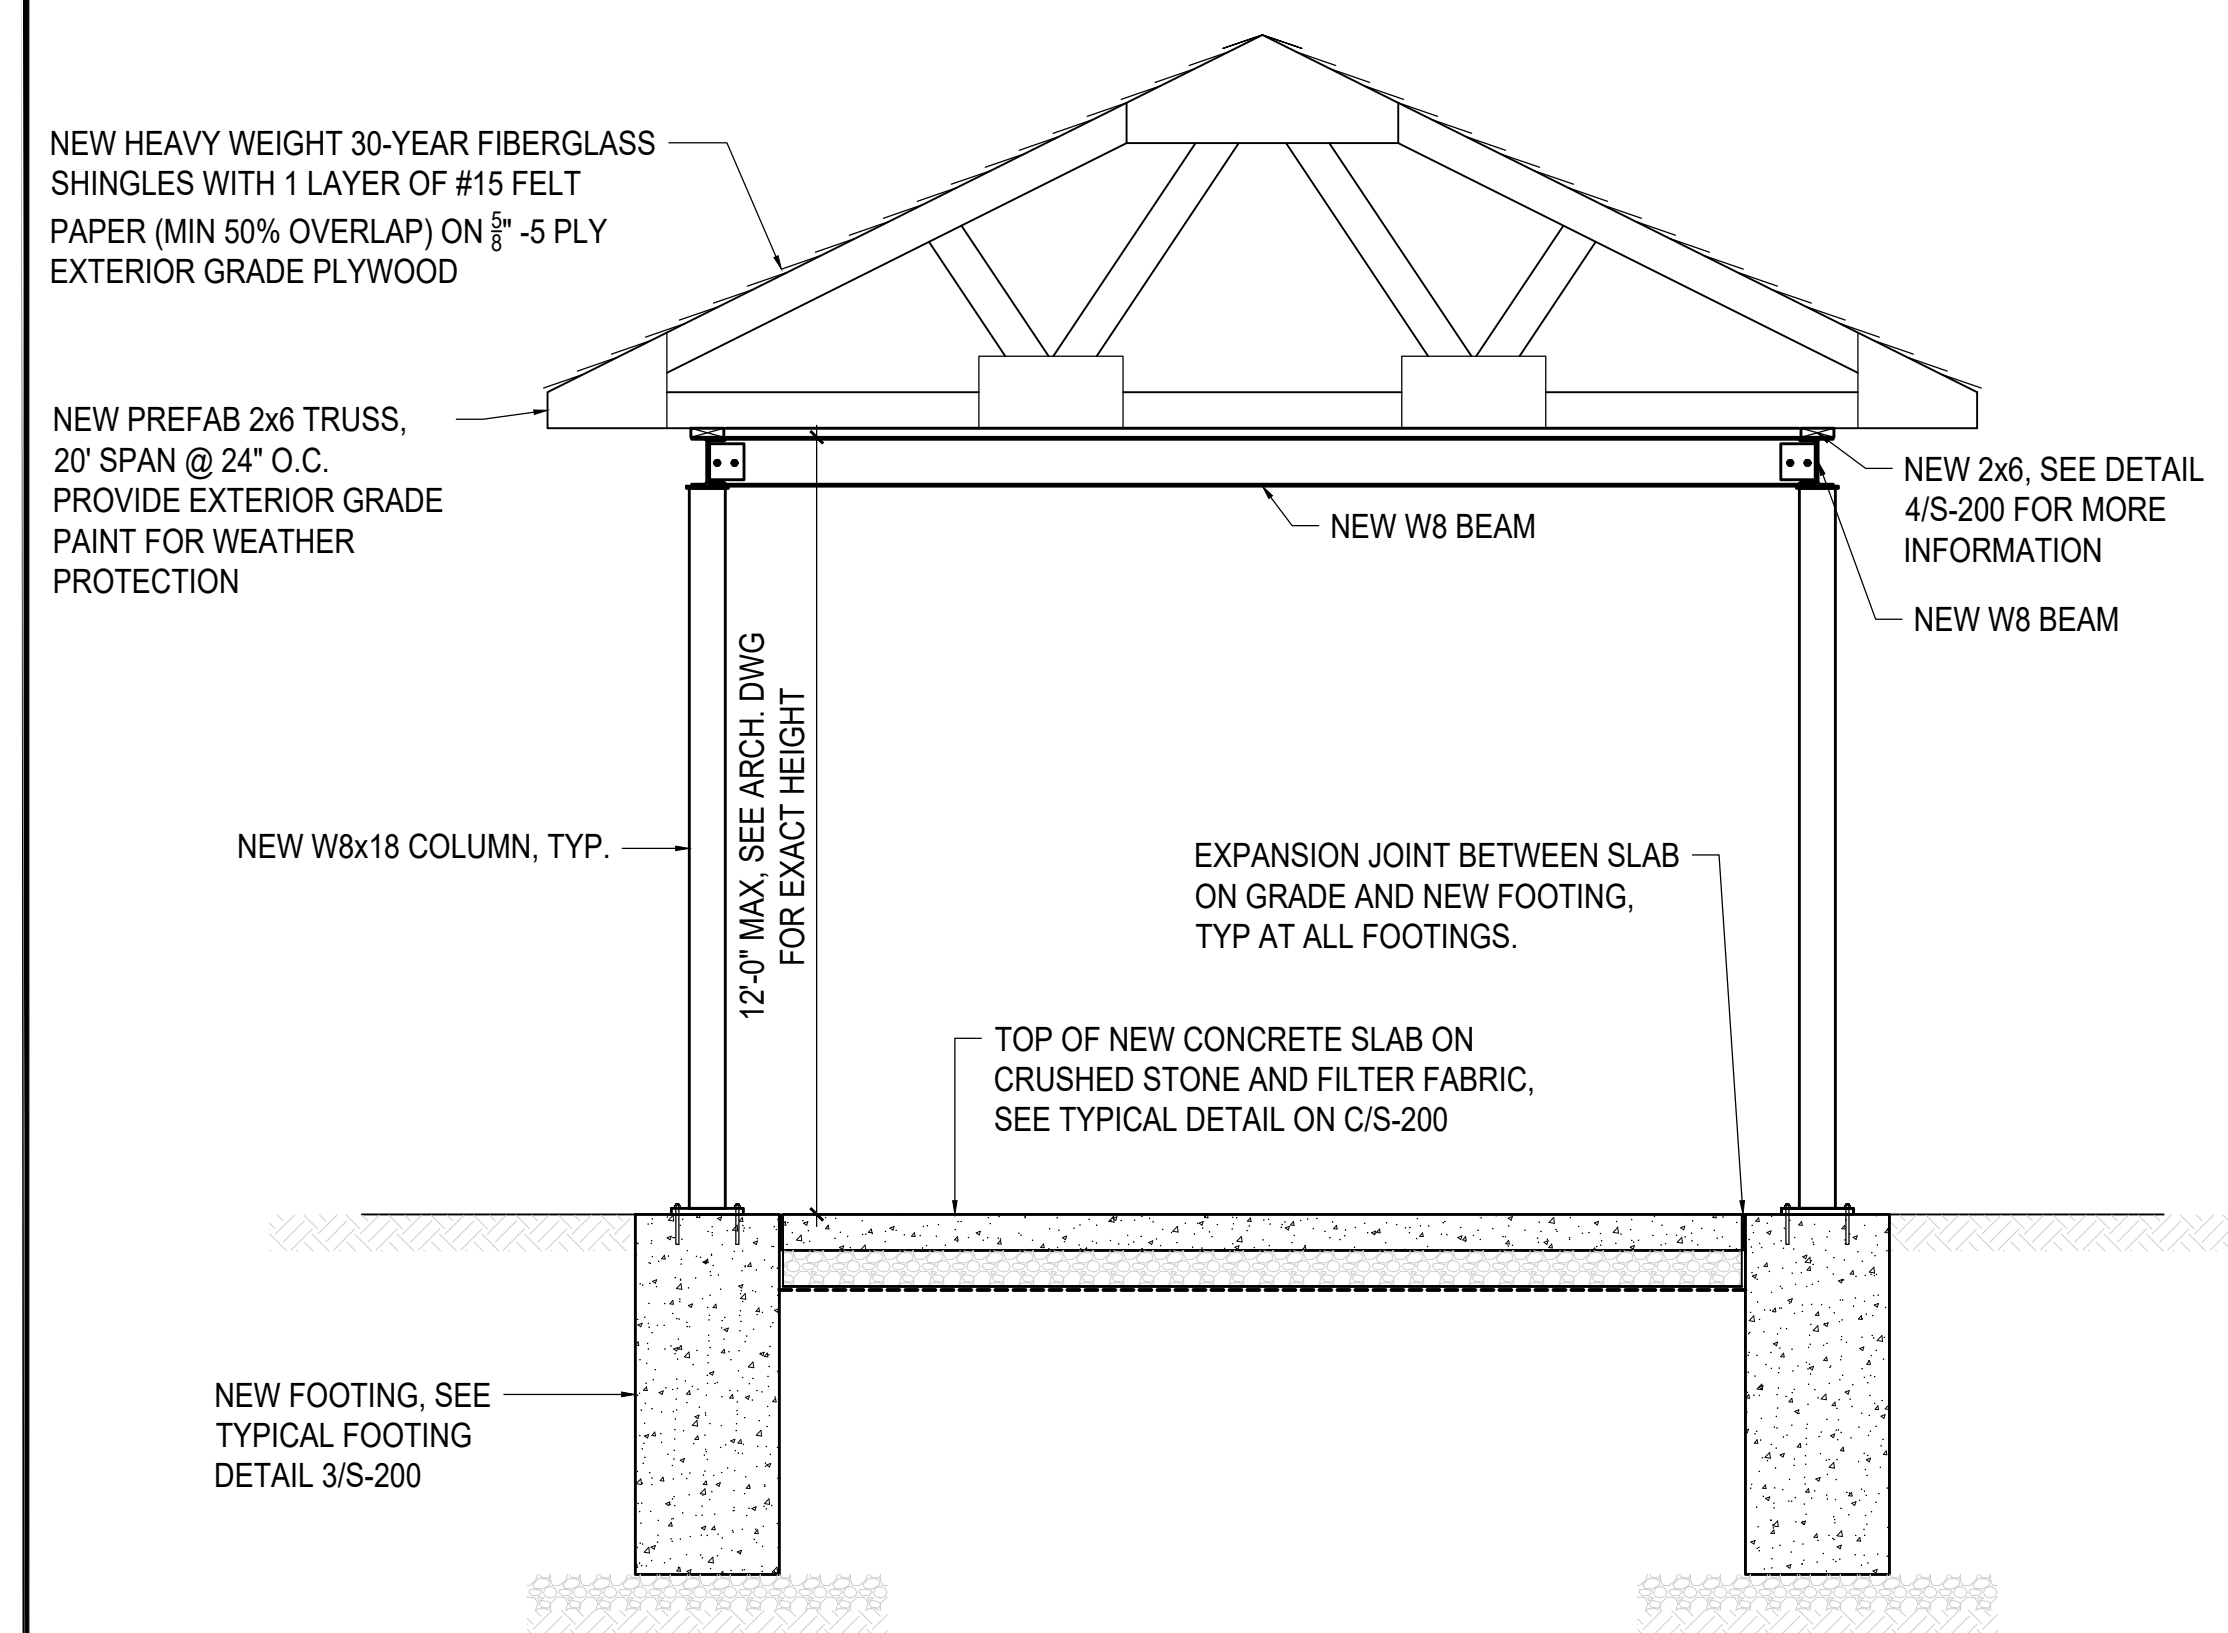


NOTE:
 1. EXPOSED CONCRETE EDGES SHALL BE CHAMFERED PER ACI.
 2. PROVIDE HIGH STRENGTH NON-SHRINK GROUT BELOW JIB BASE PLATE AND TOP OF FOUNDATION.
 3. CAST ANCHOR BOLTS INTO FOUNDATION WITH THE USE OF A BOLT TEMPLATE.
 4. PROJECT SPECIFIC SHOP DRAWINGS AND SUBMITTALS TO BE SUBMITTED FOR EOR APPROVAL PRIOR TO FABRICATION AND INSTALLATION.


2 SECTION
 3/8"=1'-0"

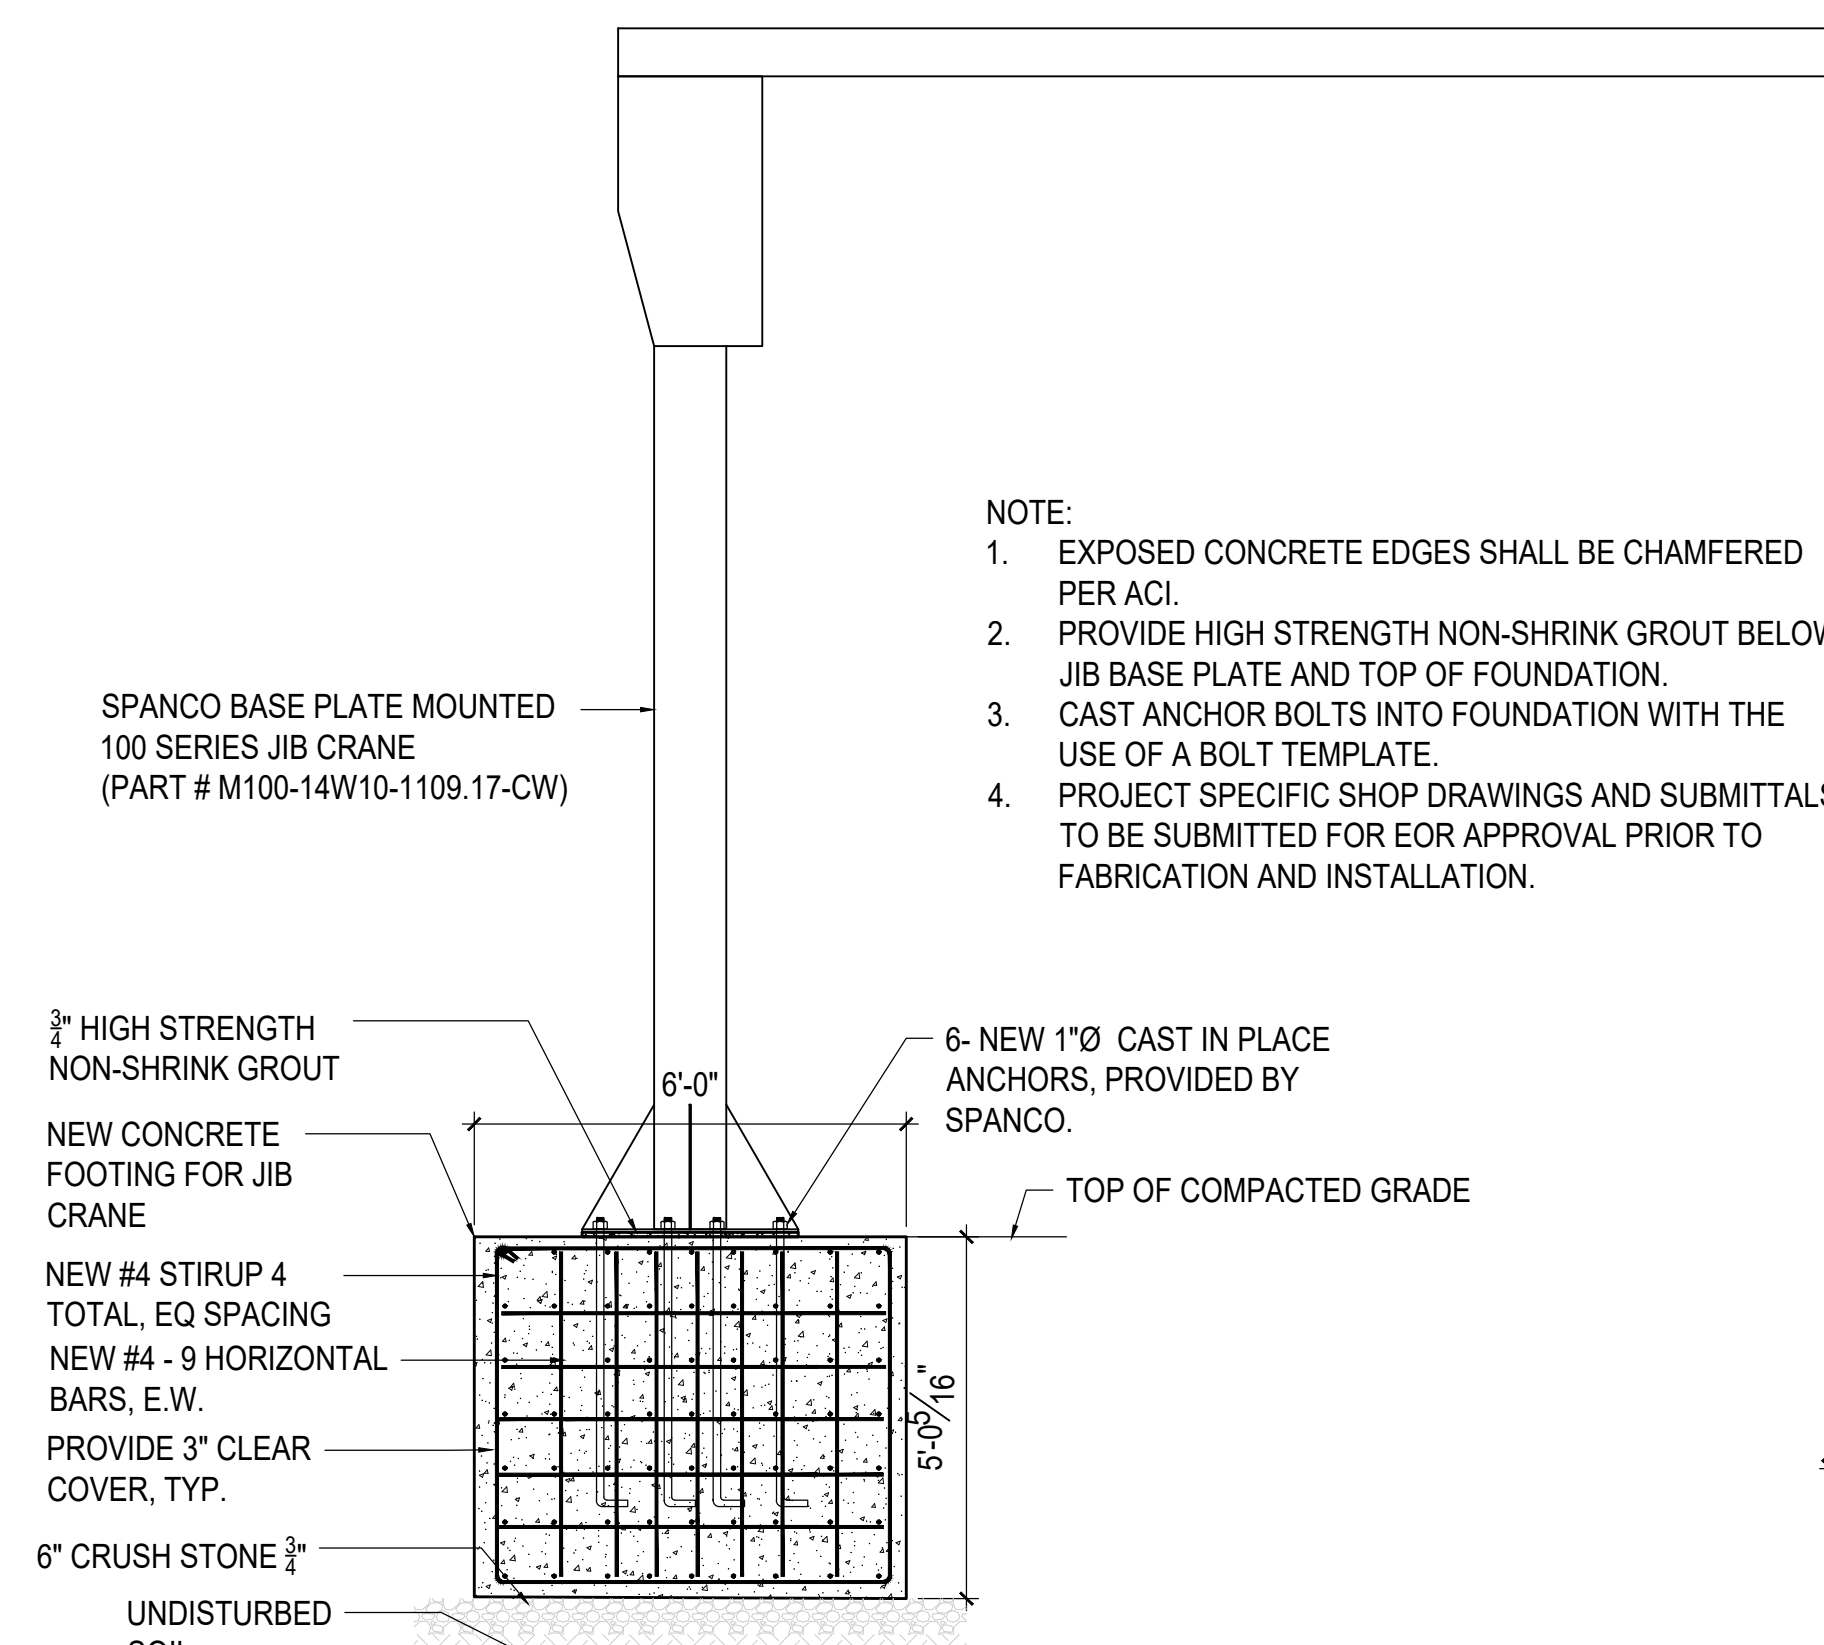


A TYPICAL BEAM TO BEAM CONNECTION
 1 1/2"=1'-0"

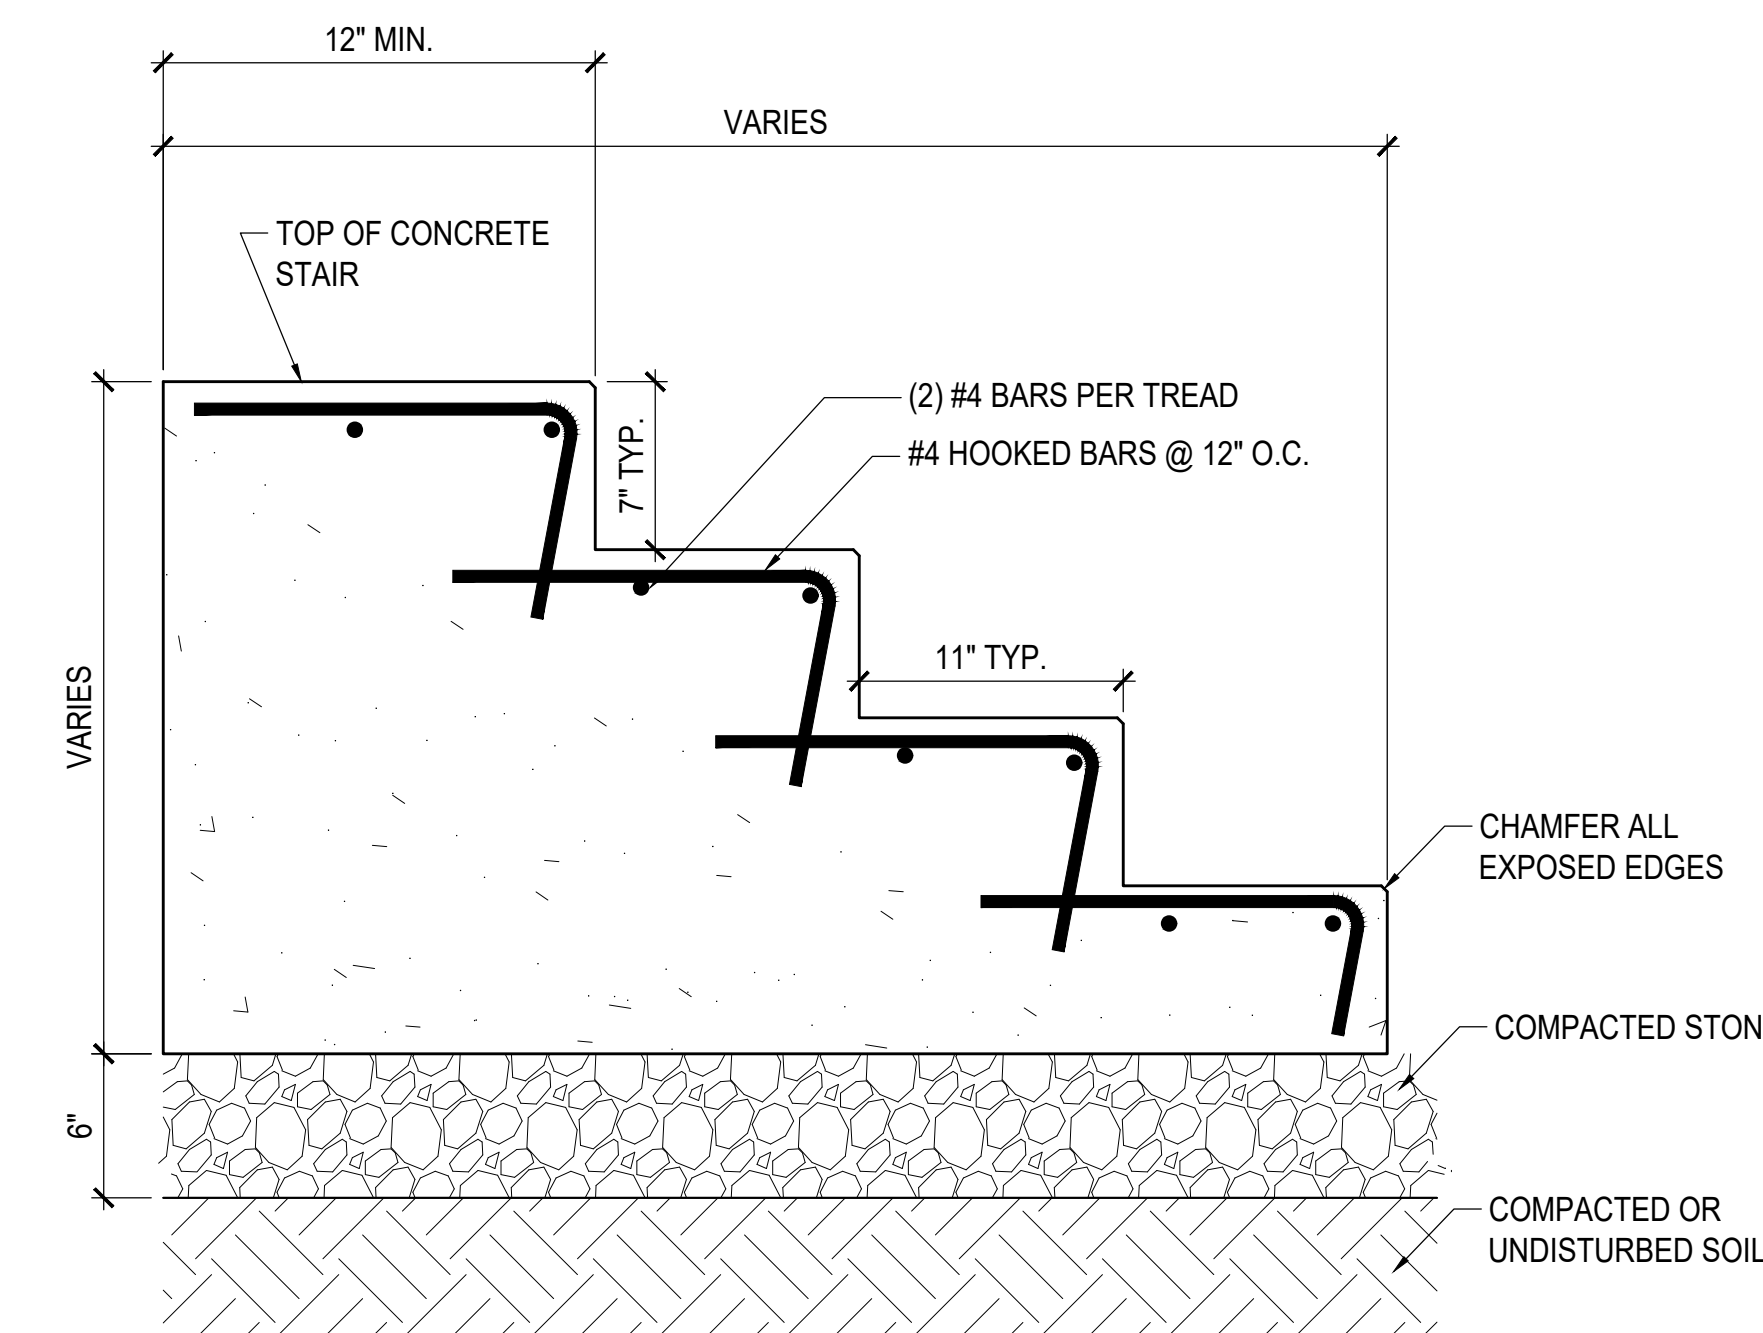


B TYPICAL CONCRETE STAIR DETAIL
 1 1/2"=1'-0"

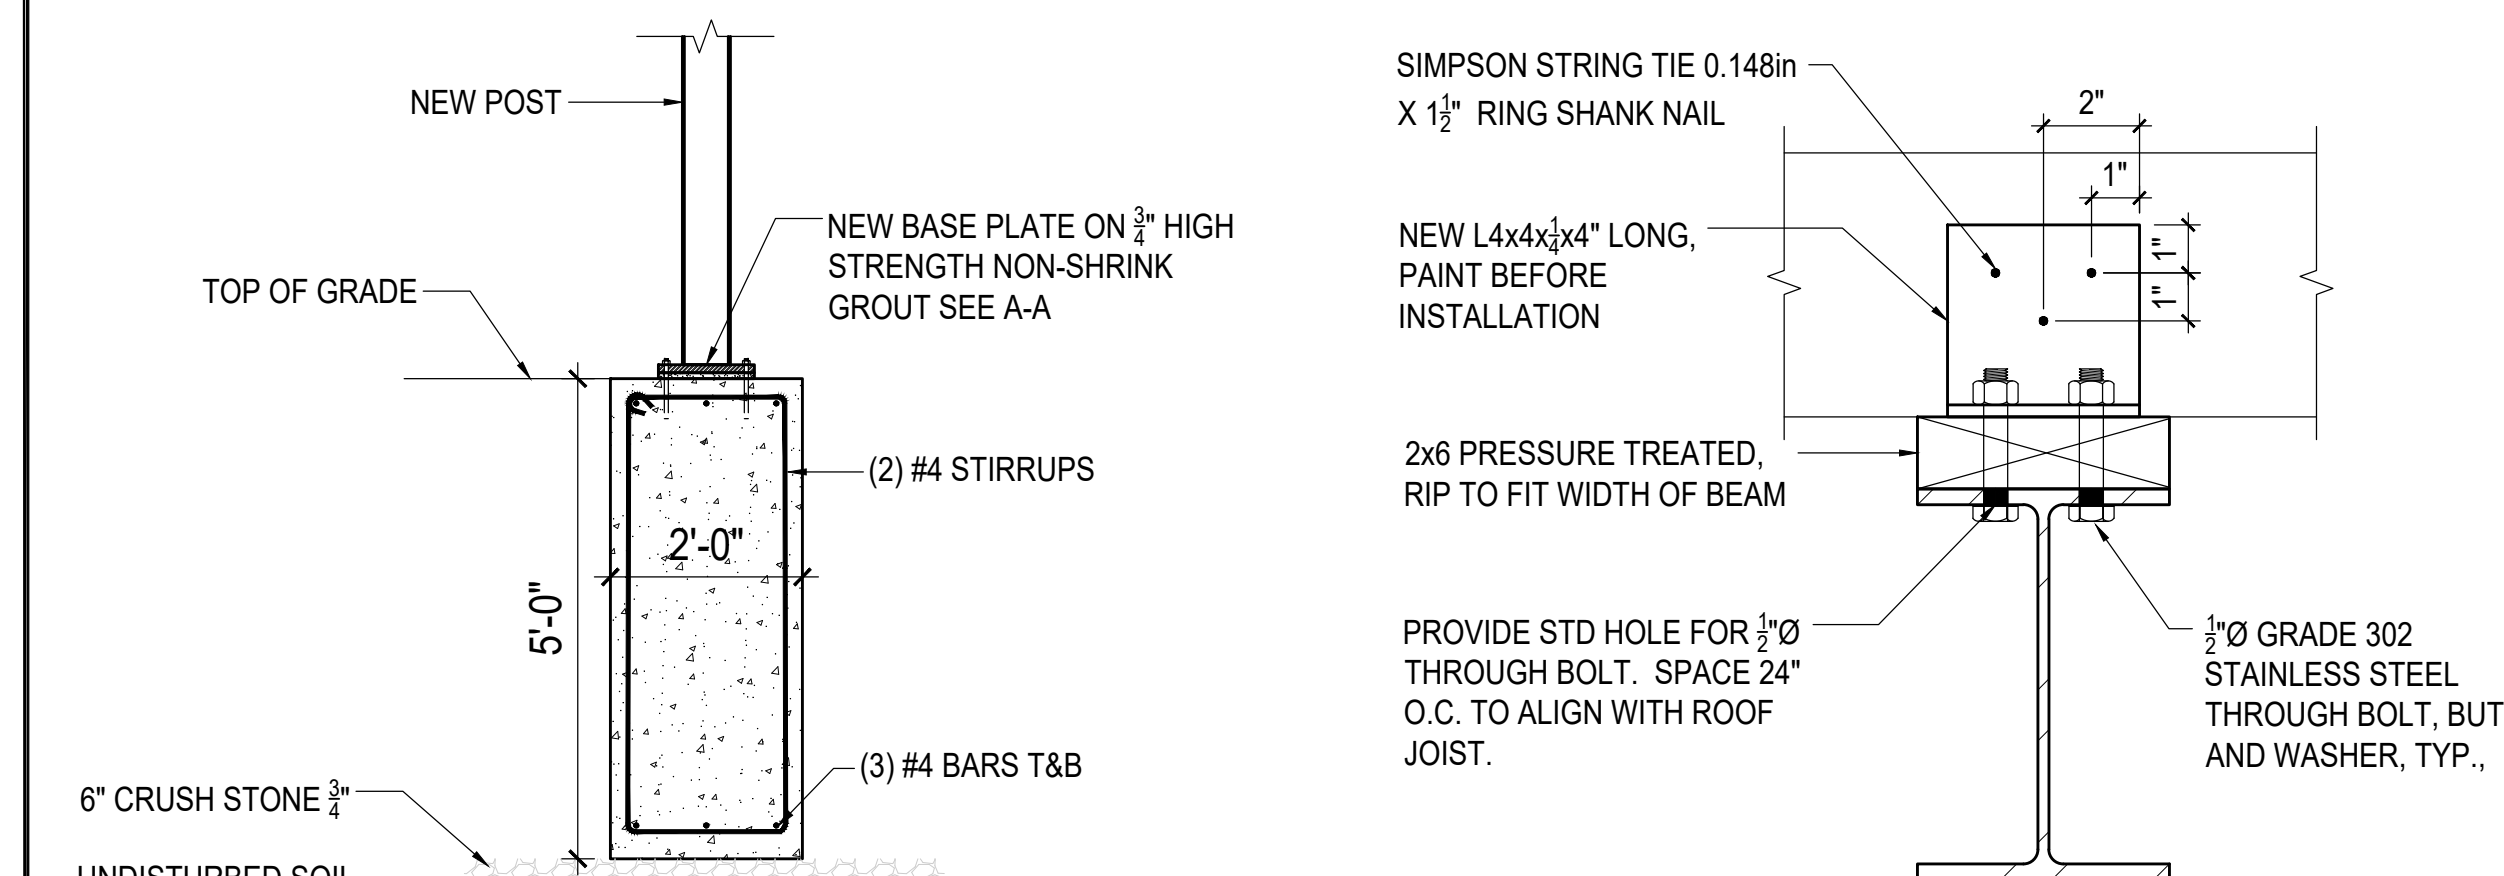

3 TYPICAL FOOTING DETAIL
 1/2"=1'-0"

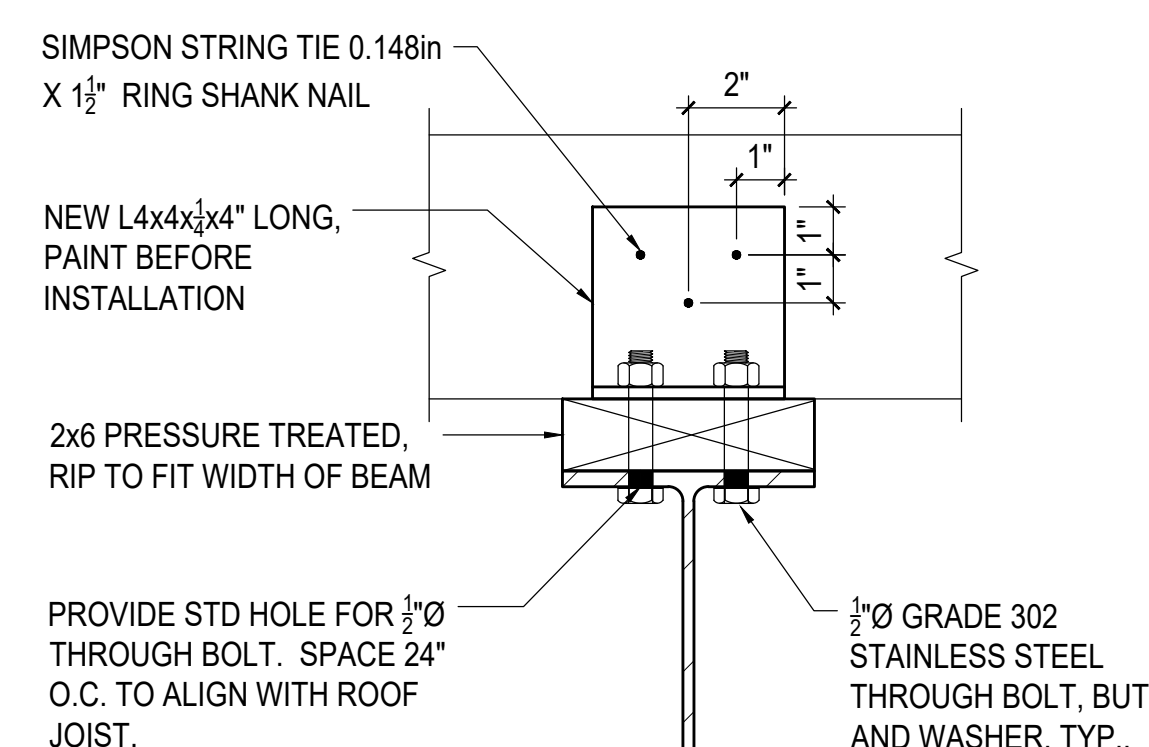

4 DETAIL
 3"=1'-0"

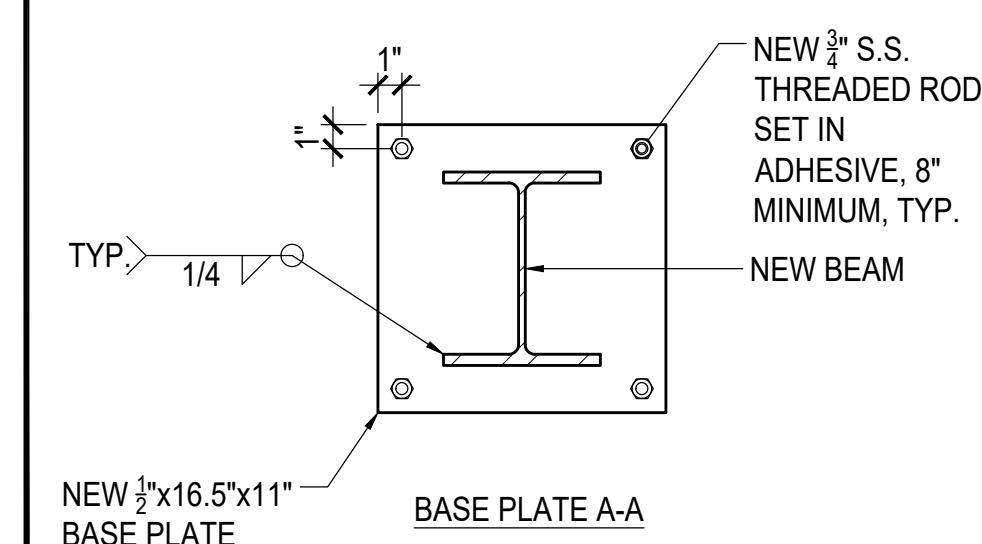

C TYPICAL SLAB ON GRADE DETAIL
 1"=1'-0"

