
TOWN OF BROOKFIELD, CONNECTICUT WATER POLLUTION CONTROL AUTHORITY

ROLLINGWOOD CONDOMINIUMS SEWER IMPROVEMENTS IN TOWN OF BROOKFIELD FAIRFIELD COUNTY, CONNECTICUT

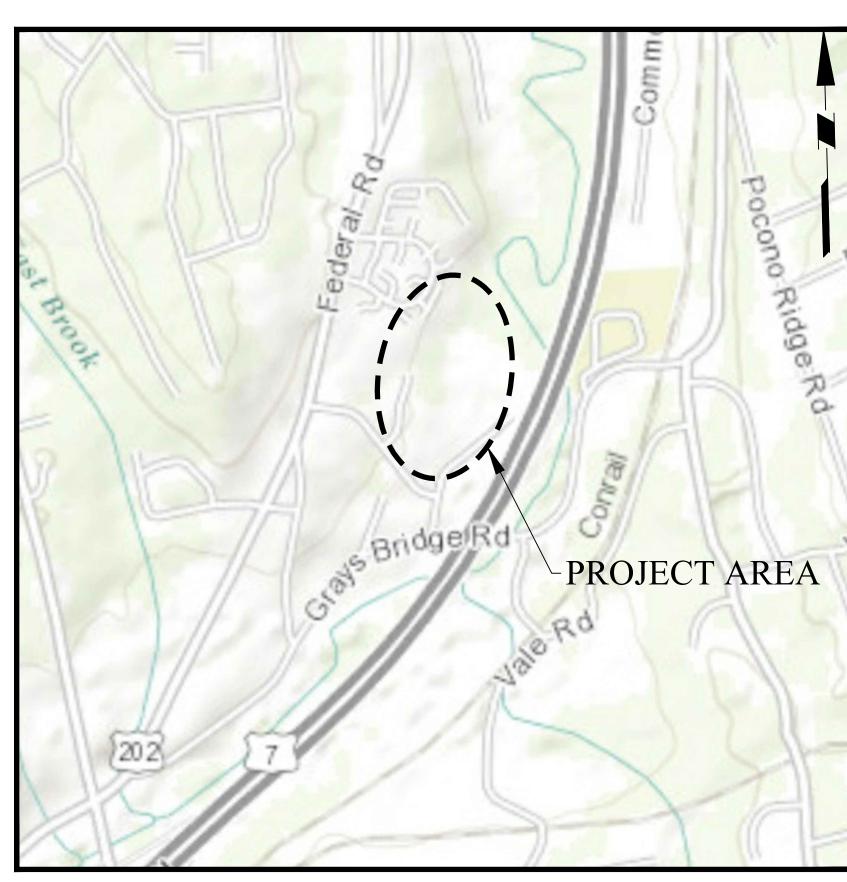

VICINITY MAP

SCALE: 1" = 1000'

DRAWING LIST					
SHEET NO. PAGE NO. DRAWING TITLE					
CS001	1 OF 7	COVER SHEET			
CU101 2 OF 7 UTILITY PLAN (1 OF 2)		UTILITY PLAN (1 OF 2)			
CU102	3 OF 7	UTILITY PLAN (2 OF 2)			
CU201	4 OF 7	SANITARY SEWER PROFILES			
CE101	5 OF 7	SEDIMENT AND EROSION CONTROL PLAN (1 OF 2)			
CE102	6 OF 7	SEDIMENT AND EROSION CONTROL PLAN (2 OF 2)			
CS501	7 OF 7	DETAILS			

OWNER:

ROLLINGWOOD CONDOMINIUM ASSOCIATION
100 POCONO ROAD

BROOKFIELD, CT 06804

AGENCY:

BROOKFIELD WATER POLLUTION CONTROL AUTHORITY
100 POCONO ROAD
BROOKFIELD, CT 06804

rawing Title

ENGINEER:

LANGAN, CT, INC.
707 WESTCHESTER AVENUE, SUITE 304

WHITE PLAINS, NY 10604

WARNING: IT IS A VIOLATION OF THE NYS EDUCATION LAW ARTICLE 145 FOR ANY PERSON, UNLESS HE IS ACTING UNDER THE DIRECTION OF A LICENSED PROFESSIONAL ENGINEER, TO ALTER THIS ITEM IN ANY WAY.

				OF COMMECTION OF COMME	
10,	/26/16	Revised per Inland Wetland Commission Comments	1.	1 1 1 1 1 1 1 1 1 1 1 1 1 1 1 1 1 1 1	10/26/16
	Date	Description	No.	SIGNATURONALENG	DATE SIGNE
		REVISIONS		PROFESSIONAL ENGINEER CT Lic	

707 Westchester Avenue, Suite 304, White Plains, NY 10604
T: 914.323.7400 F: 914.323.7401 www.langan.com

Langan Engineering, Environmental, Surveying and Landscape Architecture, D.P.C. S.A.
Langan Engineering, Environmental, Surveying and Landscape Architecture, D.P.C.
Langan Engineering and Environmental Services, Inc.

Langan CT, Inc.

Langan International LLC Collectively known as Langan ROLLINGWOOD
CONDOMINIUM
SEWER IMPROVEMENTS

TOWN OF BROOKFIELD

FAIRFIELD COUNTY

COVER SHEET

Project No.

190011002

Date


AUGUST 5, 2016


Scale


N.T.S.


Drawn By Checked By EK CU

Submission Date

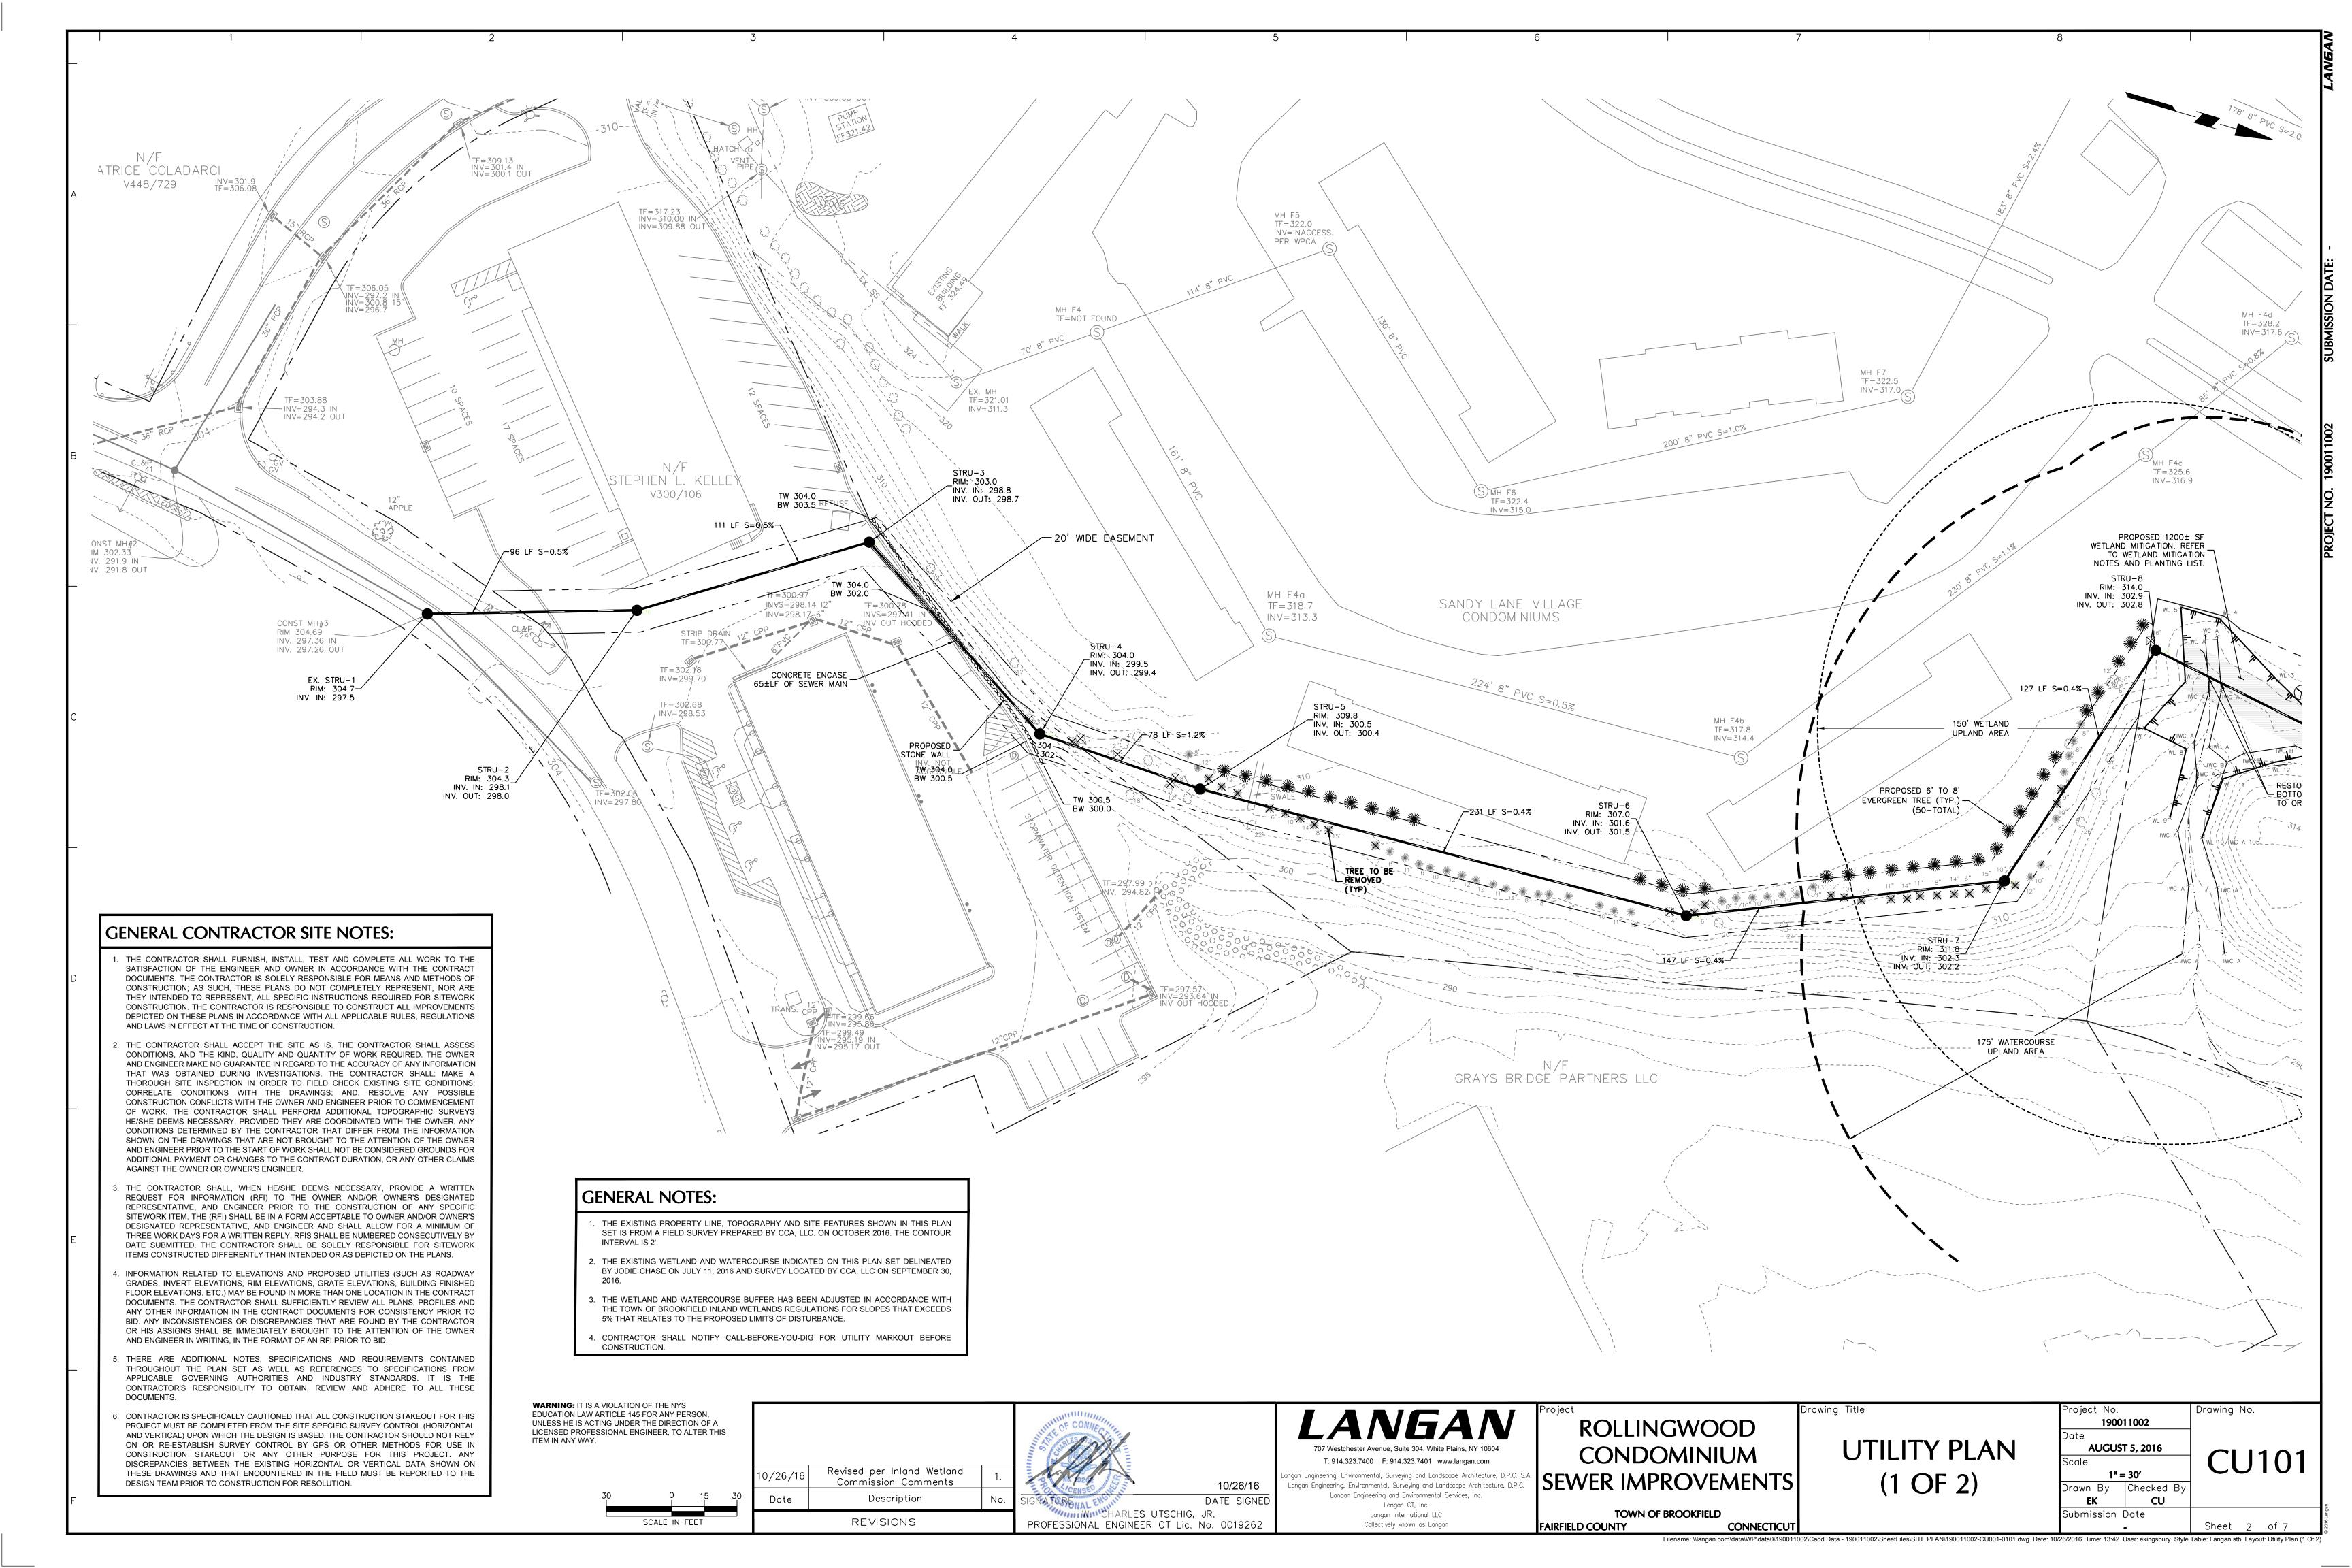

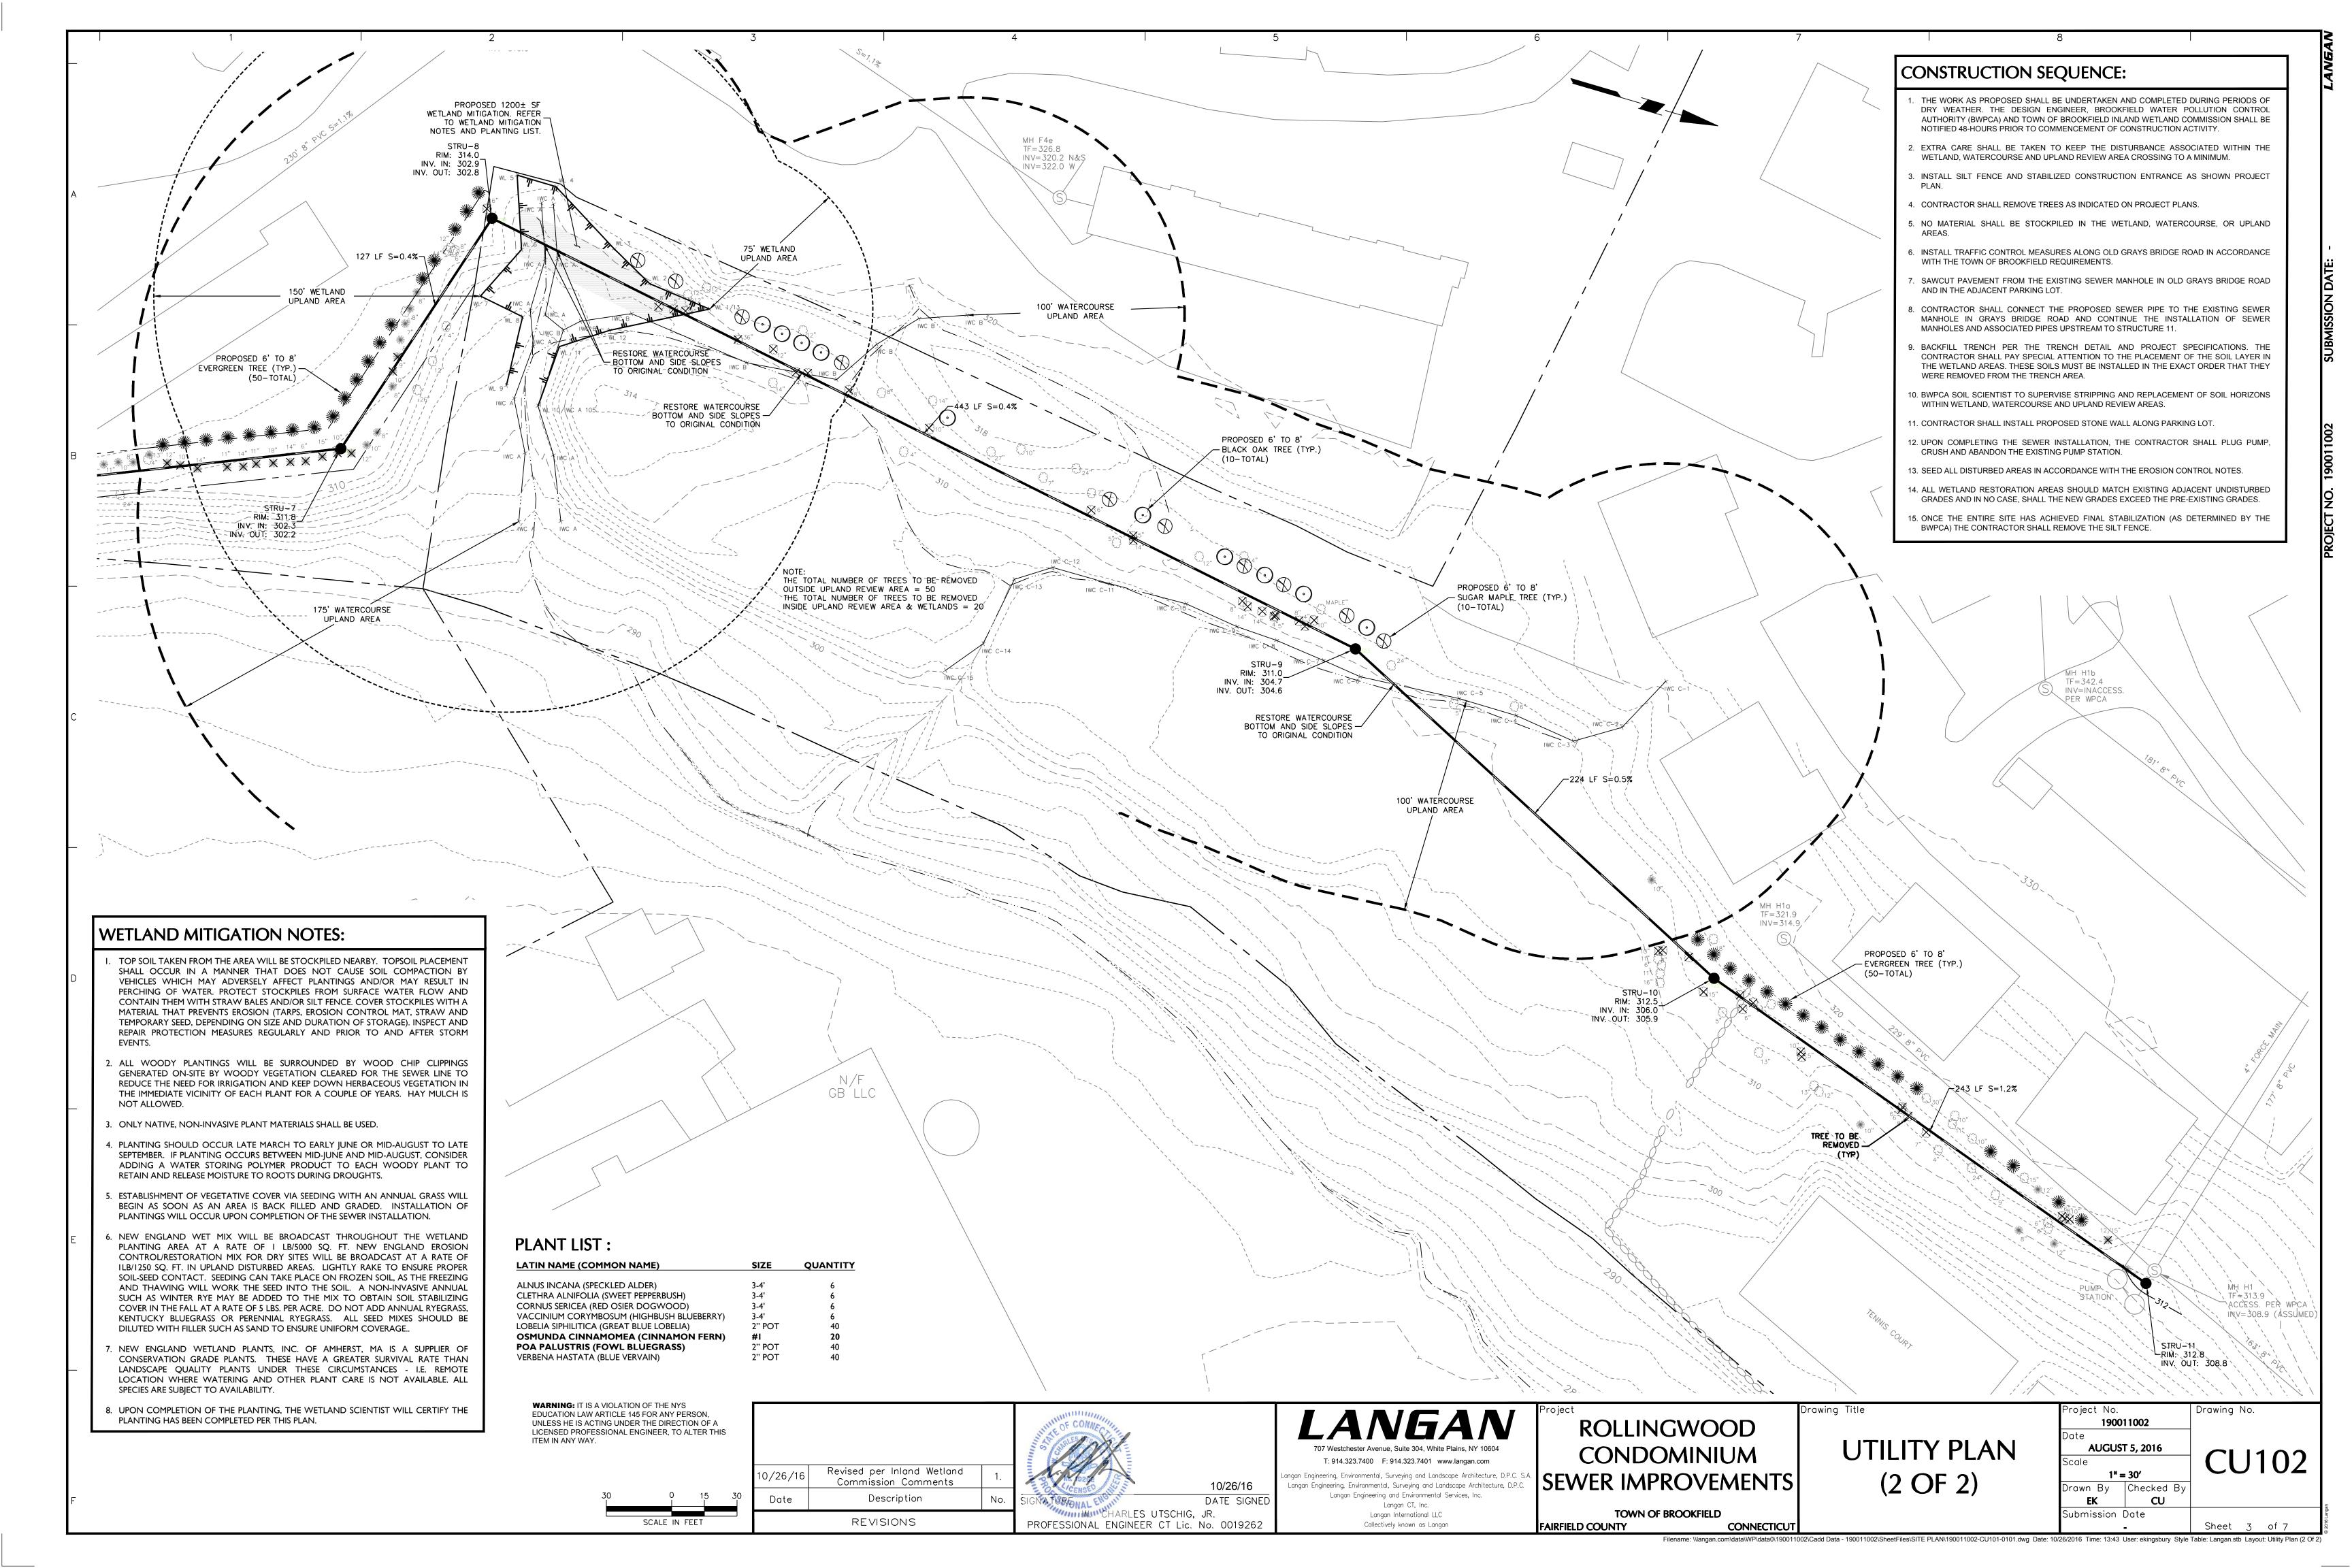

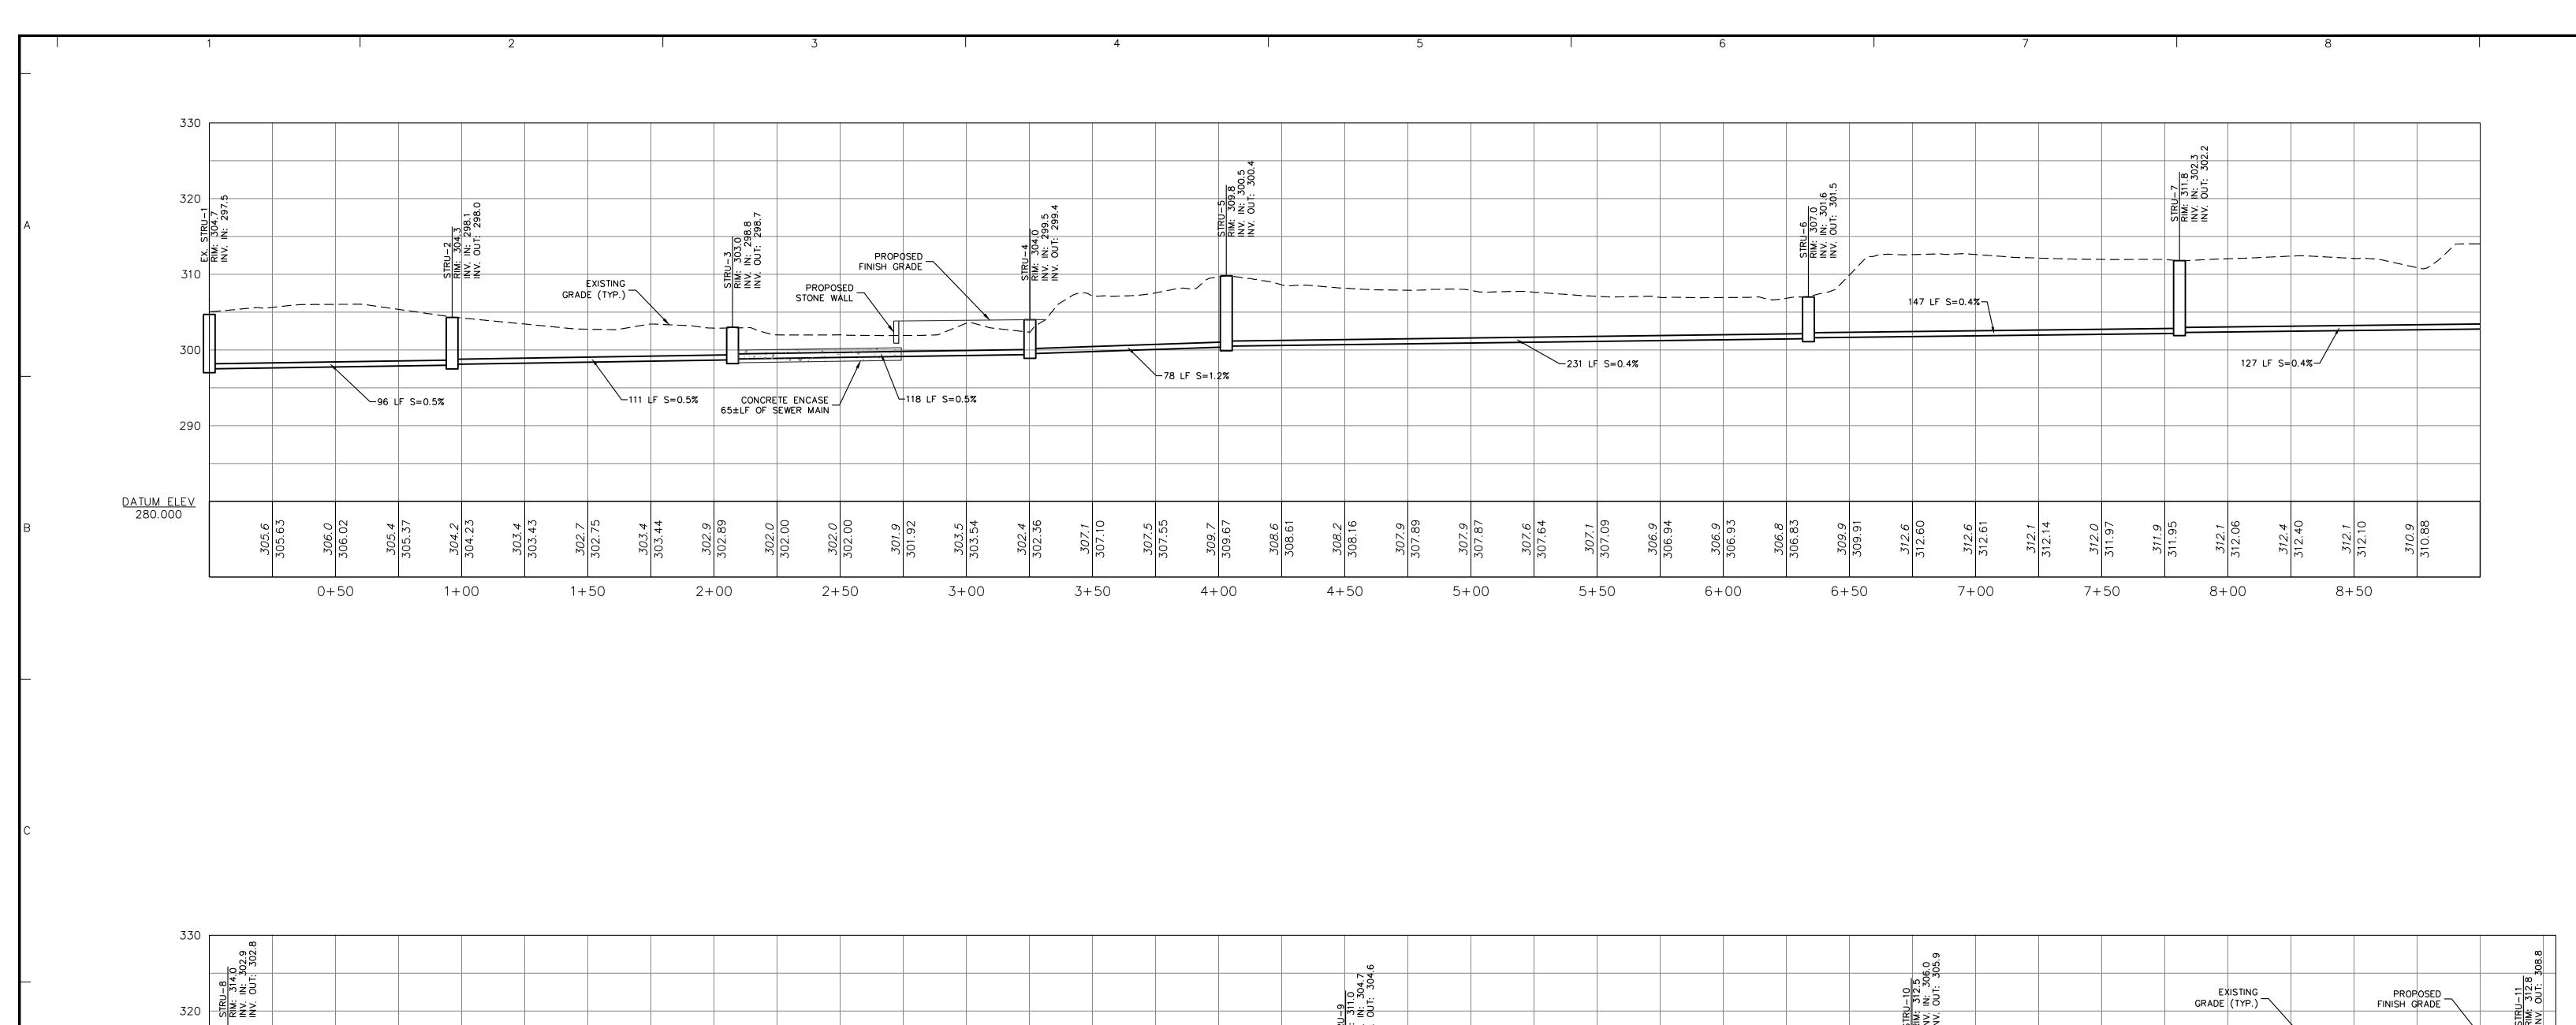

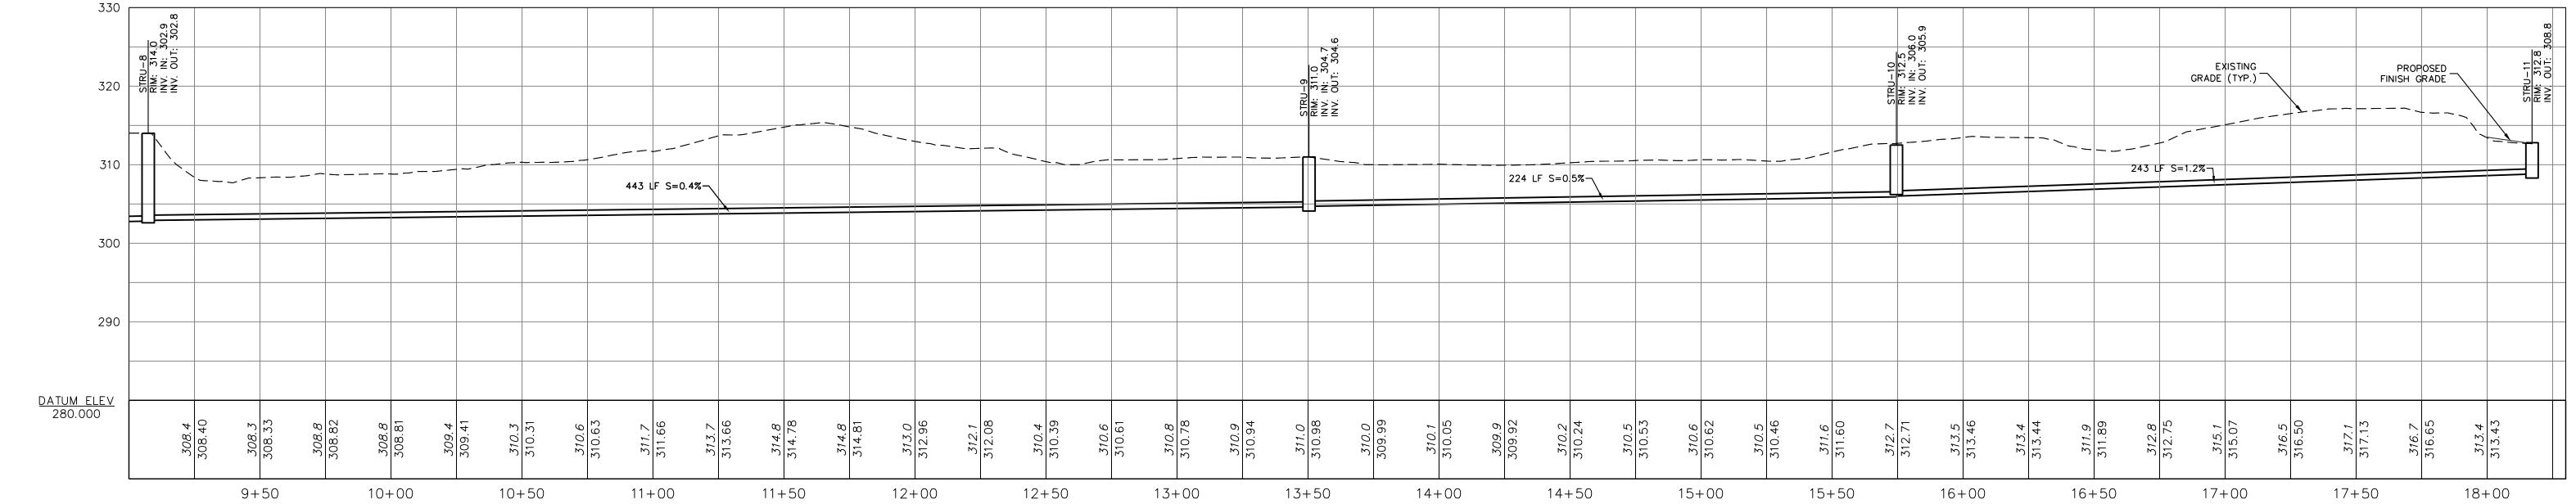

WARNING: IT IS A VIOLATION OF THE NYS
EDUCATION LAW ARTICLE 145 FOR ANY PERSON,
UNLESS HE IS ACTING UNDER THE DIRECTION OF A
LICENSED PROFESSIONAL ENGINEER, TO ALTER THIS
ITEM IN ANY WAY

			OF CONNECTION OF	
10/26/16	Revised per Inland Wetland Commission Comments	1.		10/26/16
Date	Description	No.	SIGNATURENALENGIA	DATE SIGNED
	REVISIONS		PROFESSIONAL ENGINEER CT Lic.	

707 Westchester Avenue, Suite 304, White Plains, NY 10604
T: 914.323.7400 F: 914.323.7401 www.langan.com

Langan Engineering, Environmental, Surveying and Landscape Architecture, D.P.C. S.A.
Langan Engineering, Environmental, Surveying and Landscape Architecture, D.P.C.
Langan Engineering and Environmental Services, Inc.
Langan CT, Inc.

Langan International LLC Collectively known as Langan ROLLINGWOOD
CONDOMINIUM
SEWER IMPROVEMENTS
TOWN OF BROOKFIELD

CONNECTICUT


FAIRFIELD COUNTY


SANITARY SEWER PROFILE


Filename: \\langan.com\data\\\PW\data\\190011002\Cadd Data - 190011002\SheetFiles\SITE PLAN\190011002-CU201-0101.dwg Date: 10/25/2016 Time: 17:28 User: ekingsbury Style Table: Langan.stb Layout: 190011002-CU201-0101


Drawing Title

Sheet 4 of 7

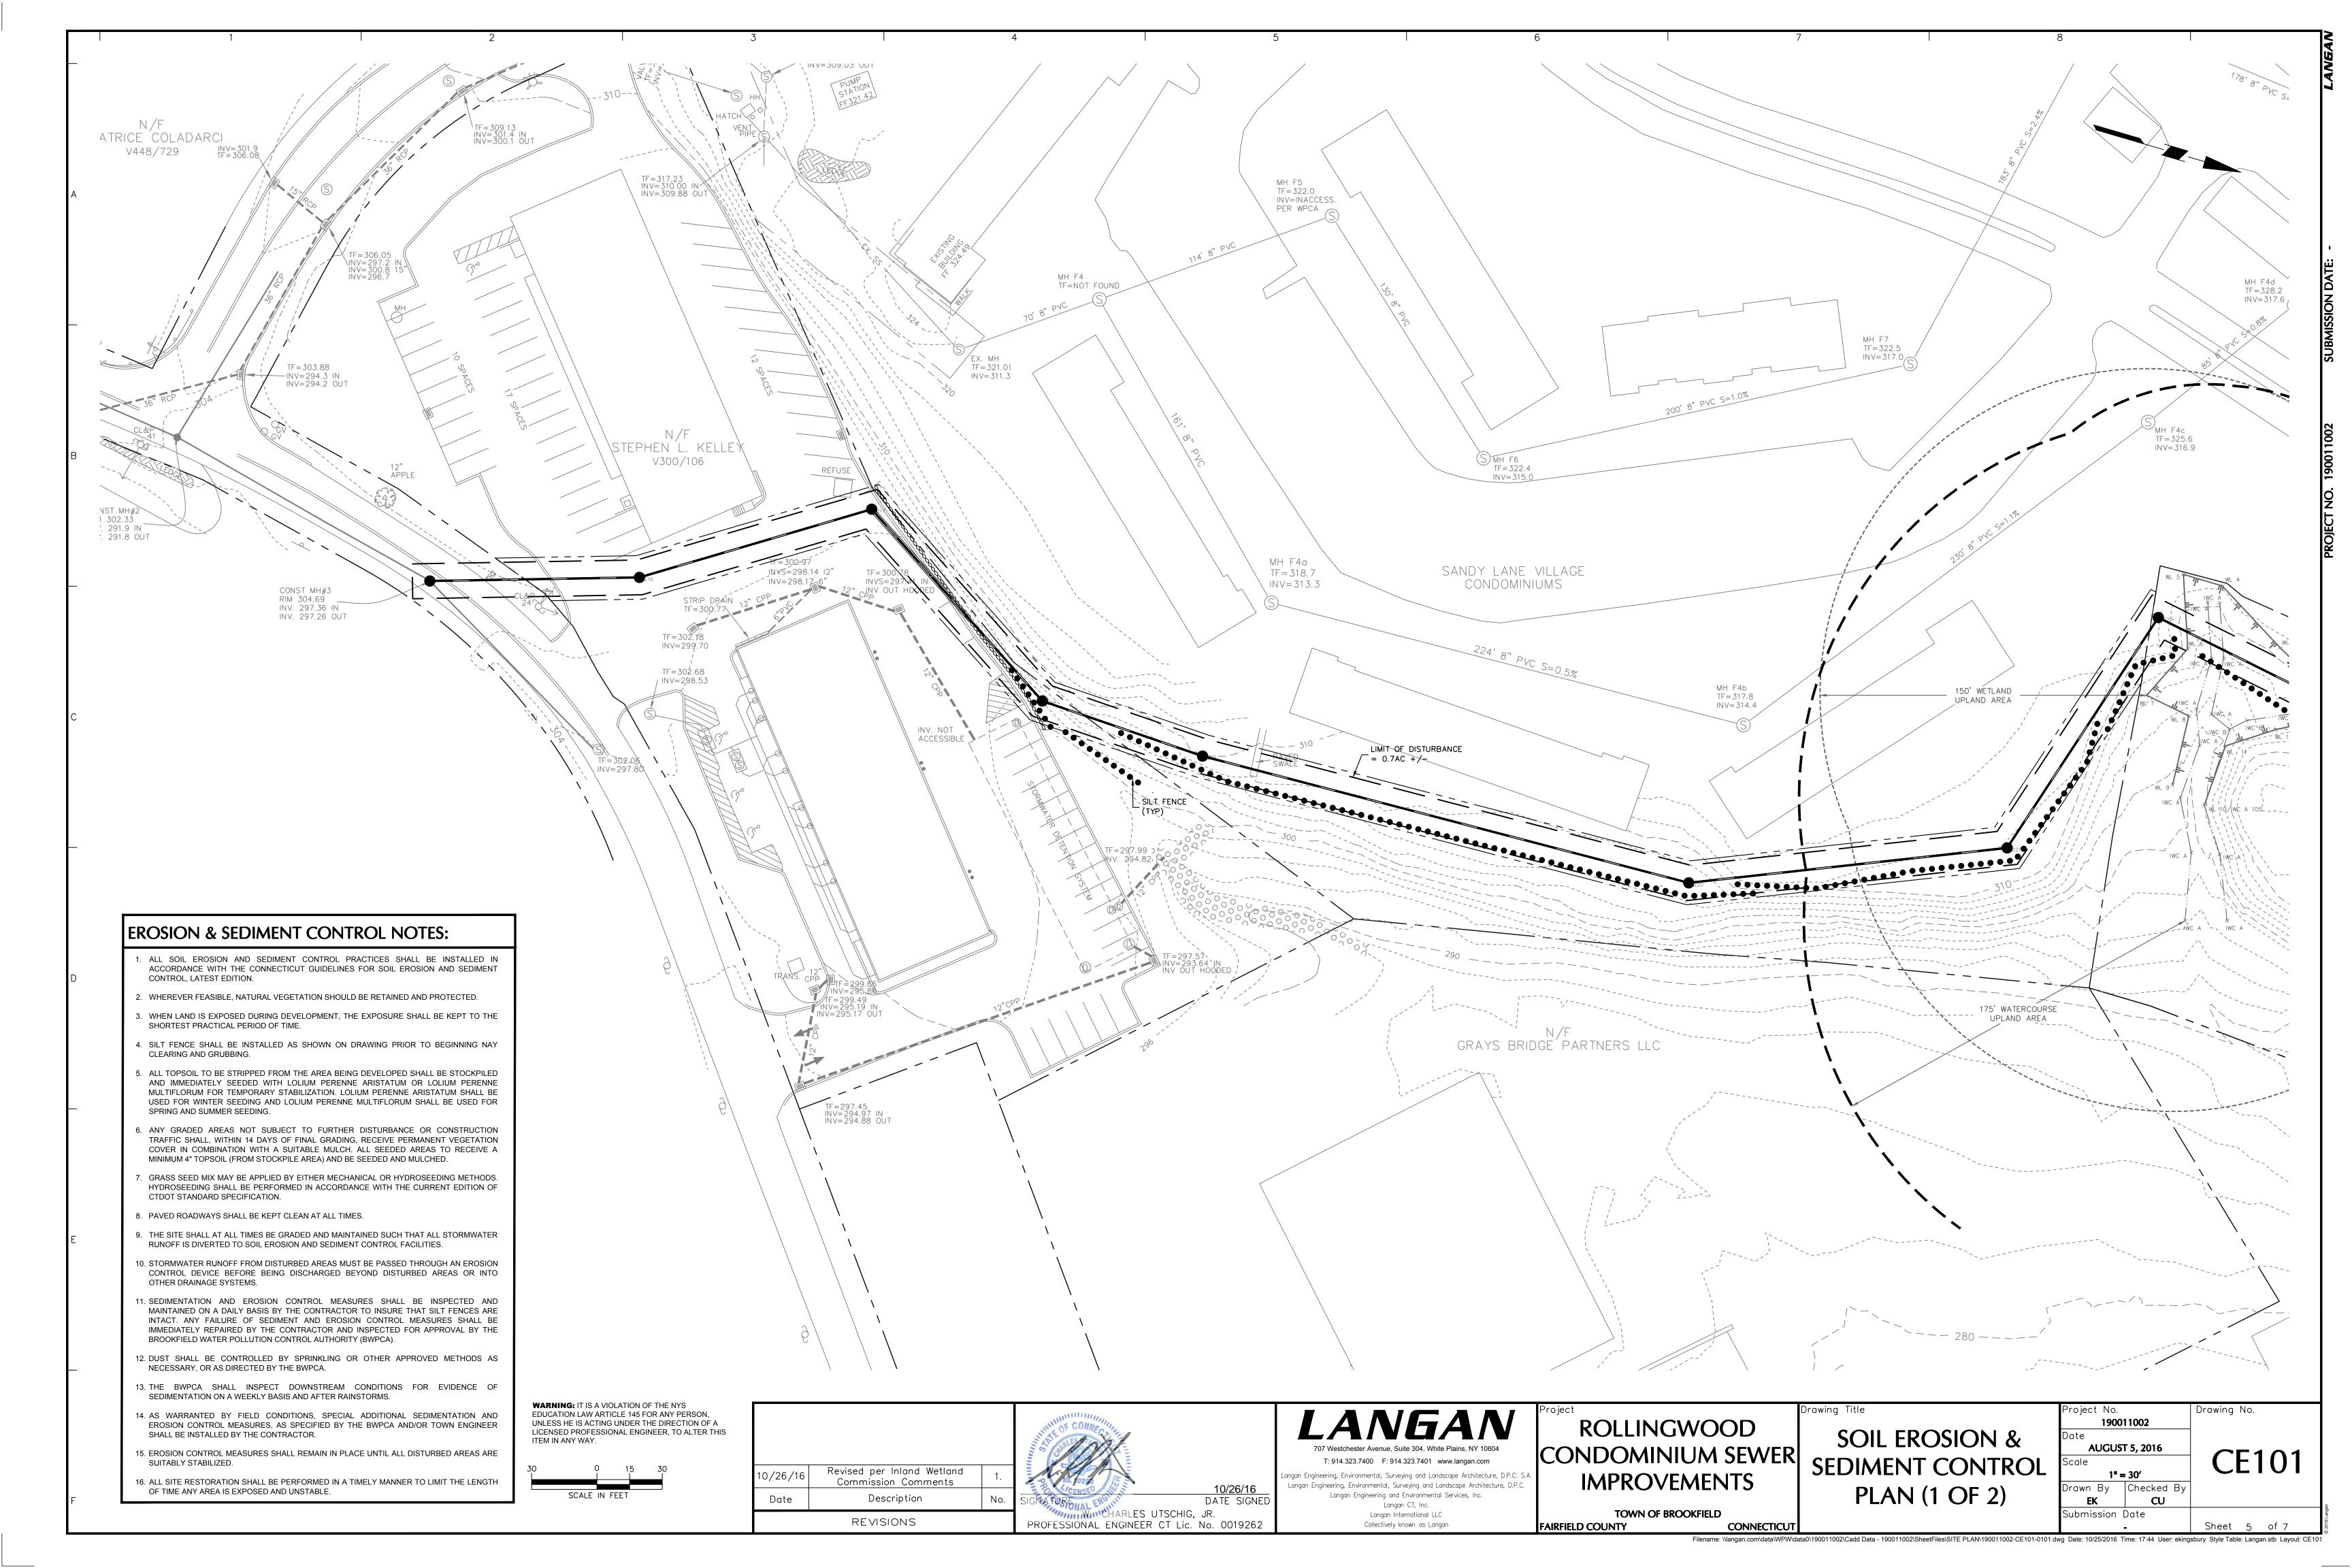


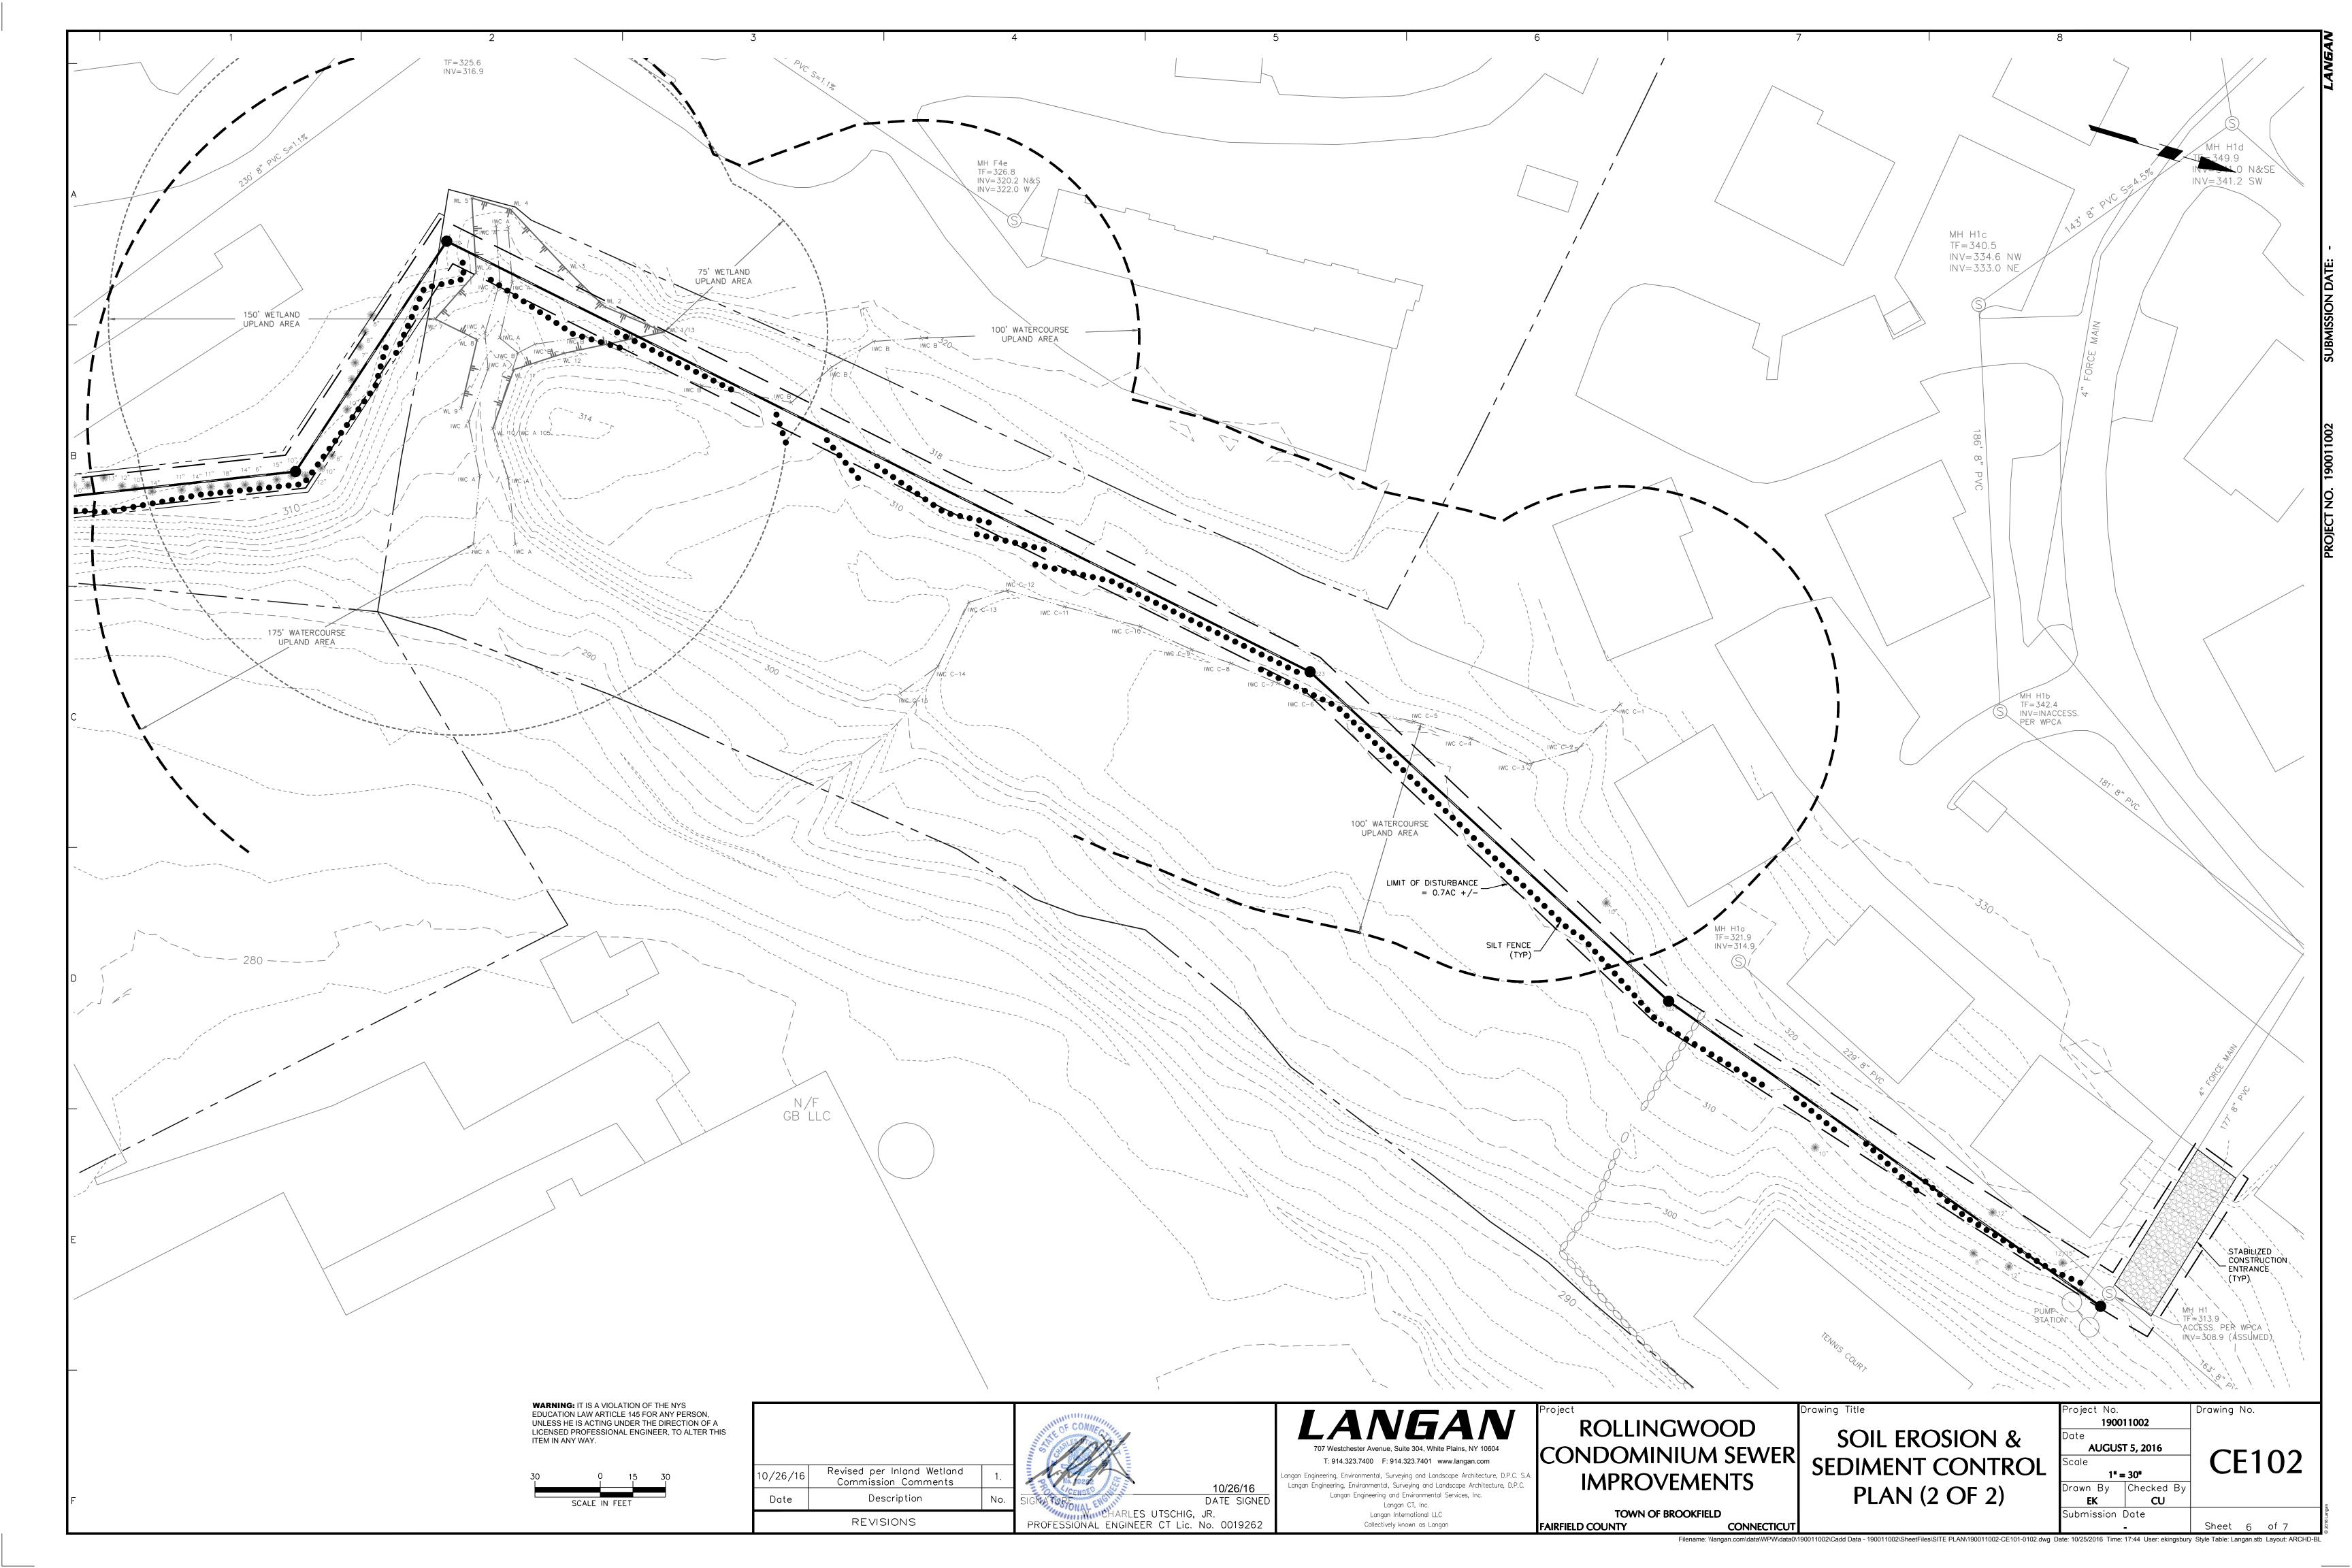

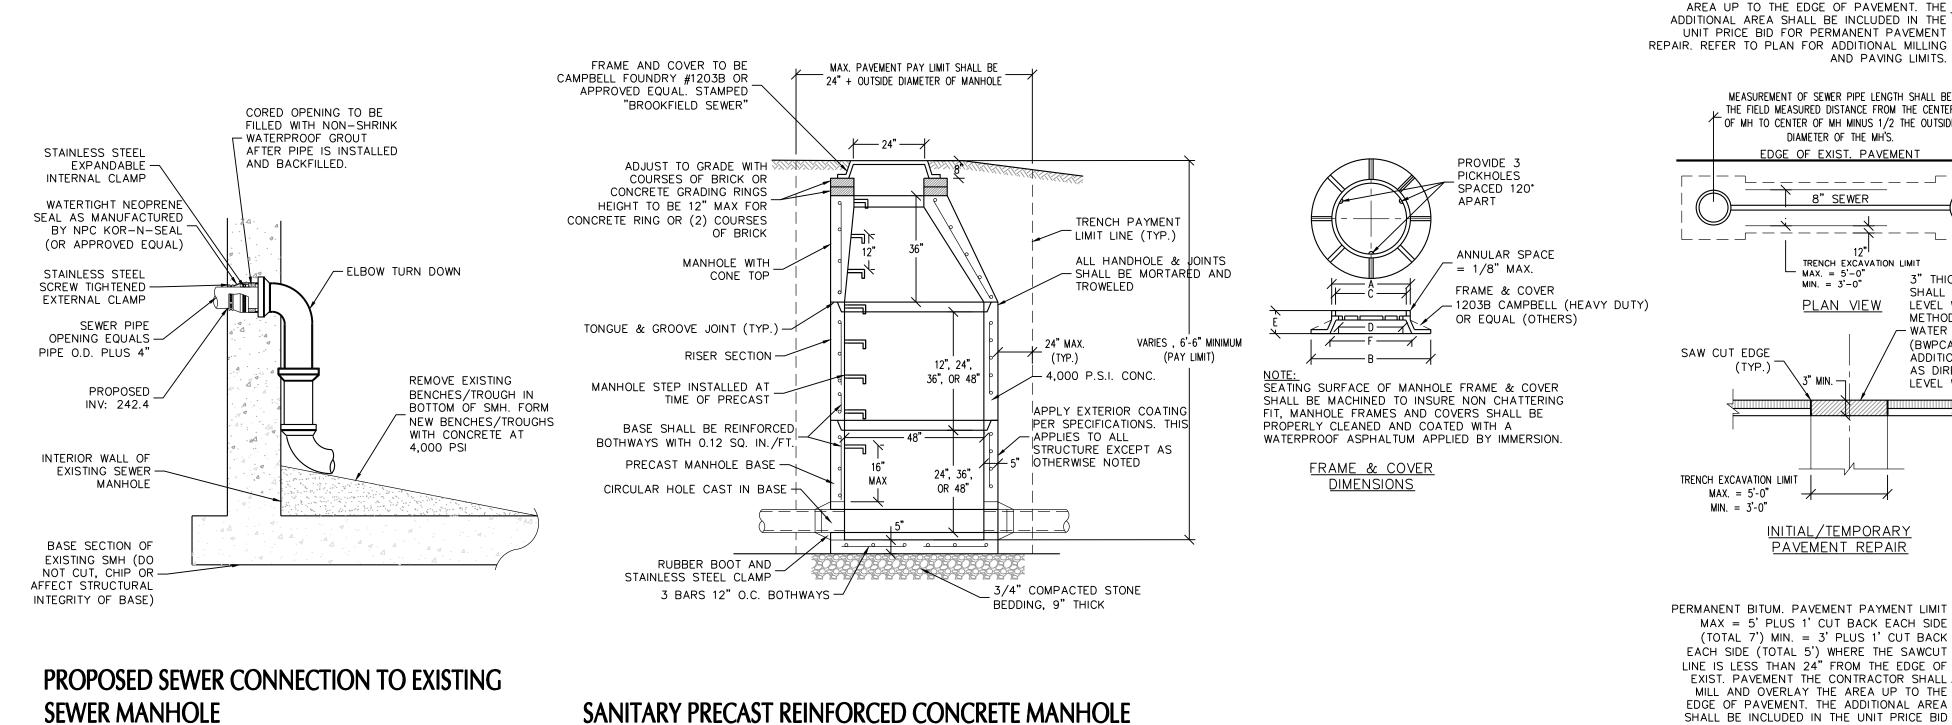


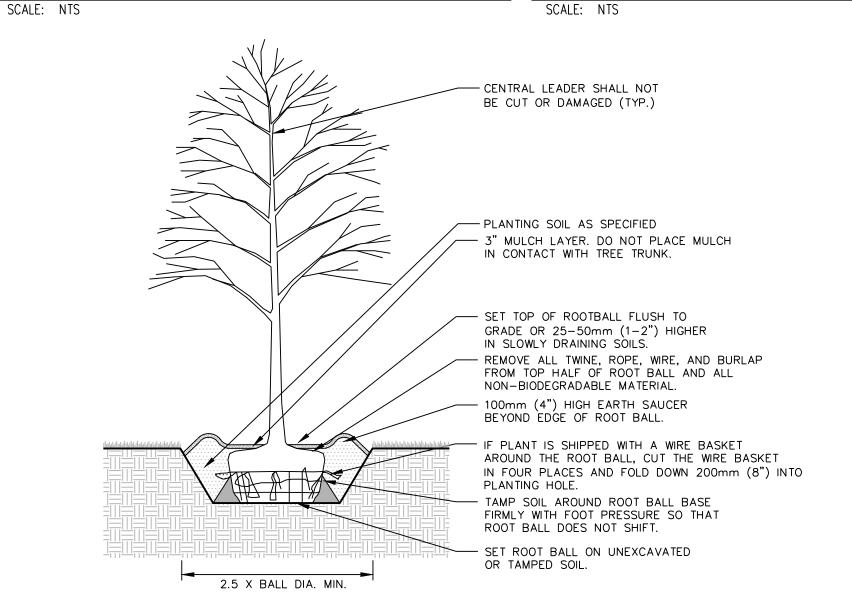

DECIDUOUS TREE PLANTING

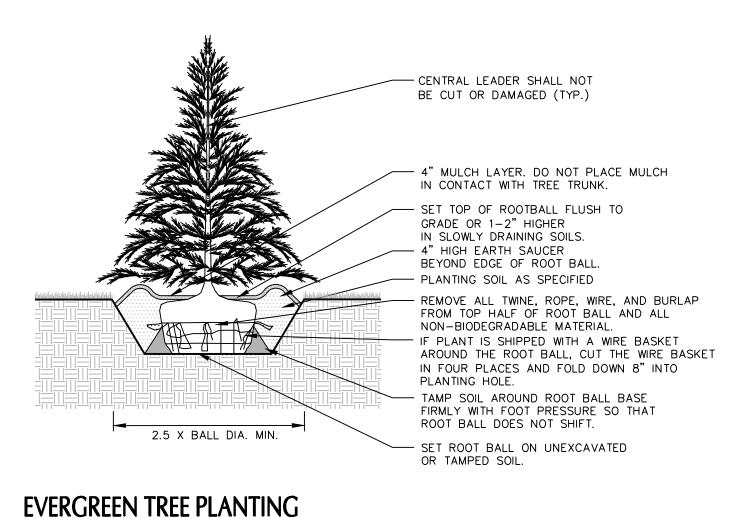

WARNING: IT IS A VIOLATION OF THE NYS EDUCATION LAW ARTICLE 145 FOR ANY PERSON, UNLESS HE IS ACTING UNDER THE DIRECTION OF A LICENSED PROFESSIONAL ENGINEER, TO ALTER THIS

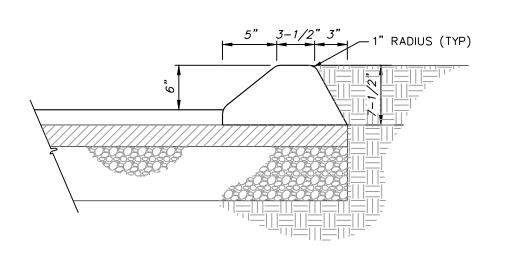

ASPHALT CURB

SCALE: NTS


<u>SPECIES</u>

TEMPORARY	GROUND	STABILIZATION
		-

<u>SPECIES</u>	LBS.	PER ACRE	<u>PER</u>	1000	S.F
ANNUAL RYEGRASS PERENIAL RYEGRASS OATS WINTER RYE WINTER WHEAT MILLET SUDANGRASS BUCKWHEAT WEEPING LOVEGRASS DOT ALL PURPOSE MIX		40 40 86 120 120 20 30 15 5		1.0 1.0 2.0 3.0 0.5 0.7 0.4 0.2 3.4	
SEEDBED PREPARATION					
LIMESTONE (50% Ca + MgO'5) CLAY, CLAY LOAM, HIGH ORGANIC SANDY LOAM, LOAM, SILT LOAM LOAMY SAND, SAND FERTILIZER (10-20-10 OR EQUIV.)	SOIL	6000 4000 2000 500		135 90 45 11	
MULCH					
UNROTTED SALT HAY, HAY, SMALL GRAIN STRAW		1 1/2 TO 2 TONS	0	70-	90

PERMANENT GROUND STABILIZATION

SPREADING FESCUE CHEWINGS RED FESCUE KENTUCKY BLUEGRASS PERENIAL RYEGRASS	15 15 25 10	0.3 0.3 0.6 0.2
SEEDBED PREPARATION		
LIMESTONE (50% Ca + MgO'5) CLAY, CLAY LOAM, HIGH ORGANIC SOIL SANDY LOAM, LOAM, SILT LOAM LOAMY SAND, SAND FERTILIZER (10-20-10 OR EQUIV.)	8000 6000 4000 500	180 135 90 11

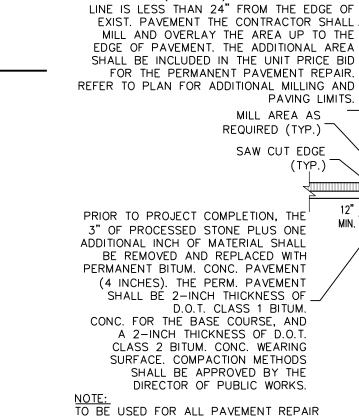

MAX. = 5'-0"

WHERE THE SAWCUT LINE IS LESS THAN 24" FROM THE EDGE OF EXIST. PAVEMENT THE

CONTRACTOR SHALL MILL AND OVERLAY THE

MEASUREMENT OF SEWER PIPE LENGTH SHALL BE

 $\bar{\ }$ of MH to center of MH Minus 1/2 the outside $\bar{\ }$

DIAMETER OF THE MH'S.

EDGE OF EXIST, PAVEMENT

8" SEWER

MAX. = 5'-0" MIN. = 3'-0"

INITIAL/TEMPORARY
PAVEMENT REPAIR

MAX = 5' PLUS 1' CUT BACK EACH SIDE

TRENCH EXCAVATION LIMIT

3" THICK OF 3/4" CLEAN PROCESSED STONE

LEVEL WITH EXISTING PAVEMENT. COMPACTION

- WATER POLLUTION CONTROL AUTHORITY

(BWPCA). CONTRACTOR SHALL INSTALL

LEVEL WITH EXISTING PAVEMENT

SHALL BE INSTALLED AND COMPACTED TO BE

METHODS SHALL BE APPROVED BY BROOKFIELD

ADDITIONAL PROCESSED STONE AS NEEDED OR

DISTURBANCE LIMIT

NOTE: THE PERMANENT PAVEMENT

ARE THE MAXIMUM LIMITS

INDICATED. IT SHOULD BE

MEASURED IN THE FIELD.

PAYMENT FOR PAVEMENT

DISTURBANCE BEYOND THE

MAXIMUM LIMIT UNLESS

PREVIOUS APPROVAL IS

DEMONSTRATED ON THE PLANS

NOTED THAT THE PAYMENT FOR

PERMANENT PAVEMENT WILL BE

MADE BASED ON THE QUANTITY

THERE WILL BE NO ADDITIONAL

GRANTED BY THE ENGINEER OR

WPCA REPRESENTATIVES IN

THE FIELD MEASURED DISTANCE FROM THE CENTER

AND PAVING LIMITS.

TACK COAT FENCE POST -(TYP.) 8' ON CENTERS FABRIC SECURED TO POST WITH METAL FASTENERS WITH REINFORCEMENT BETWEEN 2' MINIMUM FASTENER AND FABRIC SILT ACCUMULATION TO BE REMOVED AT -50% CAPACITY TRENCH EXCAVATION LIMIT MAX. = 5'-0''DIG 6" IN DEEP MIN. = 3'-0"2' MINIMUM TRENCH, BURY BOTTOM -FLAP, RAMP IN PLACE PAVEMENT REPAIR PAVEMENT REPAIR DETAIL SILT FENCE SCALE: NTS

AS DIRECTED BY BWPCA TO BE MAINTAINED SILT FENCE TO INSTALLED ON GRADE WITH NO

- LANDSCAPE PLANTINGS /--- 12" MIN. -----/\∭ _FILTER FABRIC GEOTEXTILE (TYP.) 2"-3" CLEAN CRUSHED STONE (TYP.) - COMPACTED BACKFILL DRY-LAID STONE (THICKNESS VARIES) -COMPACTED SUBGRADE

STONE RETAINING WALL MAXIMUM PAYMENT OD + 24" MAX EQUAL EQUAL -PAYMENT LINES NO ROCK TO PROTRUDE

WITHIN THIS

NOTES:

1. NO TRENCH CONTAINING SEWER SHALL BE BACKFILLED UNTIL THE WPCA HAS COMPLETED AN INSPECTION OF AND APPROVED THE WORK. 2. PROVIDE METALLIC MARKING TAPE 18" BELOW GRADE LABELED "SEWER" OVER THE MAINS, SERVICE LINES & FORCE MAINS. 3. THRUST BLOCKS SHALL BE PROVIDED AT ALL BENDS FOR FORCE MAINS.

TRENCH IN ROCK

T: 914.323.7400 F: 914.323.7401 www.langan.com

angan Engineering, Environmental, Surveying and Landscape Architecture, D.P.C


Langan Engineering, Environmental, Surveying and Landscape Architecture, D.P

Langan Engineering and Environmental Services, Inc.

Langan CT, Inc.

Langan International LLC Collectively known as Langan

TRENCH SECTIONS FOR FLEXIBLE PIPE

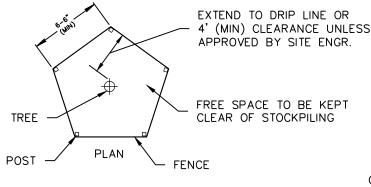

THE TREE PROTECTION SHOULD BE INSTALLED PRIOR TO ANY

TRENCH. MATTING TO BE INSTALLED OVER SILT

FABRIC AND ANCHORED BY MIN 12"

LANDSCAPE NAIL @ 1' O.C. SPACING.

CERTIFIED ARBORIST

INSTALLATION TO BE PERFORMED BY A

QUALIFIED ARBORIST AND SUPERVISED BY A

WORK IN AREA, AND REMAIN UNTIL END OF ALL WORK.

CORRECT METHOD OF TREE FENCING

TREE PROTECTION FENCE

DISCRETION

3" MULCH OR WOOD CHIPS OR AS

DIRECTED BY PROJECT FORESTER.

MATTING AT PROJECT FORESTER'S

- MULCH MAY BE PLACED UNDER

ROOT PROTECTION MATTING

LANDSCAPE NAILS @3' O.C.

ANCHORED BY MIN 12"

DETERMINED BY PROJECT

SPACING. SPECIFIC

MATERIAL TO BE

FORESTER

ROOT PROTECTION MATTING

- SNOW FENCE WELDED WIRE OR BOARD FENCE

3' LG ORANGE OR RED HEAVY WT FLAGGING @ 5' O.C

14.5 GA, 4"X2" WELDED WIRE FABRIC FENCE, 4' MIN HEIGHT 6' STEEL "T" - POST AT 10' O.C. SPACING GRADE TREE PROTECTION

ELEVATION

- SIGNAGE (TYP) @30'

MAX SPACING

1. ALL EXISTING TREES WITHIN THE LIMITS OF TREE PROTECTION FENCING. SHALL BE PROTECTED THOUGHOUT THE DURATION OF WORK. TREE PROTECTION FENCING SHALL BE INSTALLED AT THE DRIP-LINE OF THE PROTECTED TREE UNLESS CONDITIONS WARRANT THE FENCE TO BE LOCATED WITHIN THE LIMIT OF BRANCHING. THE OWNER OR DESIGN ENGINEER TO APPROVE THE LOCATION OF ALL FENCING PRIOR TO EXCAVATION.

TREE PROTECTION FENCING SHALL BE MAINTAINED TO PROTECT TREES AT ALL TIMES. ANY DAMAGED FENCING SHALL BE IMMEDIATELY REPLACED WHEN DAMAGED.

IF TREE PROTECTION FENCING NEEDS TO BE MOVED OR BREACHED DUE TO TEMPORARY CONSTRUCTION ACTIVITY WITHIN THE TREE PROTECTION ZONE, THE FENCING WILL BE RESET TO ITS ORIGINAL LOCATION IMMEDIATELY AFTER CONSTRUCTION WITHIN THE TREE PROTECTION ZONE IS COMPLETE.


4. DEMOLITION WORK ADJACENT TO PROTECTED TREES SHALL BE PERFORMED BY NON-MECHANICAL METHODS. CONTRACTOR TO PROTECT ROOT MASS AGAINST DAMAGE DURING EXCAVATION. ANY TREE ROOTS THAT ARE DISTURBED, BROKEN, OR CUT SHALL BE PRUNED BACK WITH CLEAN SHARP TOOLS.

5. ALL WORK TO BE PERFORMED UNDER THE DIRECT SUPERVISION OF EITHER THE OWNER'S REPRESENTATIVE OR THE PROJECT DESIGN ENGINEER.

6. ALL TEMPORARILY EXPOSED TREE ROOTS SHALL BE COVERED WITH 2 INCHES OF SHREDDED HARDWOOD MULCH AND THOROUGHLY IRRIGATED ON A DAILY BASIS AS DIRECTED BY THE OWNER'S REPRESENTATIVE OR THE DESIGN ENGINEER.

7. THE AREA WITHIN THE TREE PROTECTION FENCE SHALL NOT BE DISTURBED AND NO MATERIALS MAY BE STOCKPILED IN THE TREE PROTECTION AREA.


TREE VEGETATION PROTECTION BARRIER

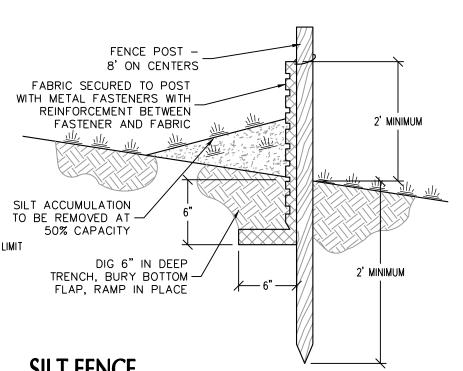

WATER MAIN -

GRADATION SHALL BE DOT NO.3 OR 50' OR GREATER AS REO'D ASTM C-33 NO.3 PAVEMENT GROUND INSTALL SUB-BUSE OF FREE <u>PROFILE</u> DRAINING BACKFILL OR ROAD (MIRAFI 140N) STABILIZATION GEOTEXTILE AS NECESSARY ON UNSTABLE SOILS

PROVIDE APPROPRIATE TRANSITION BETWEEN STABILIZED CONSTRUCTION ENTRANCE AND PUBLIC R.O.W.

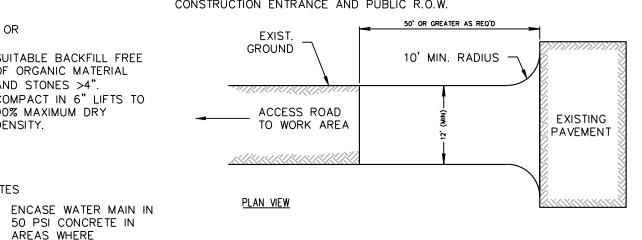

- UNDISTURBED EARTH

SUITABLE BACKFILL FREE

COMPACT IN 6" LIFTS TO

50 PSI CONCRETE IN

IS LESS THAN 1.5' AND

SEPARATION IS LESS

AREAS WHERE VERTICAL SEPARATION

HORIZONTAL

THAN 10'.

OF ORGANIC MATERIAL


AND STONES >4".

90% MAXIMUM DRY

DENSITY.

ROADWAY SURFACE OR

FINISH GRADE

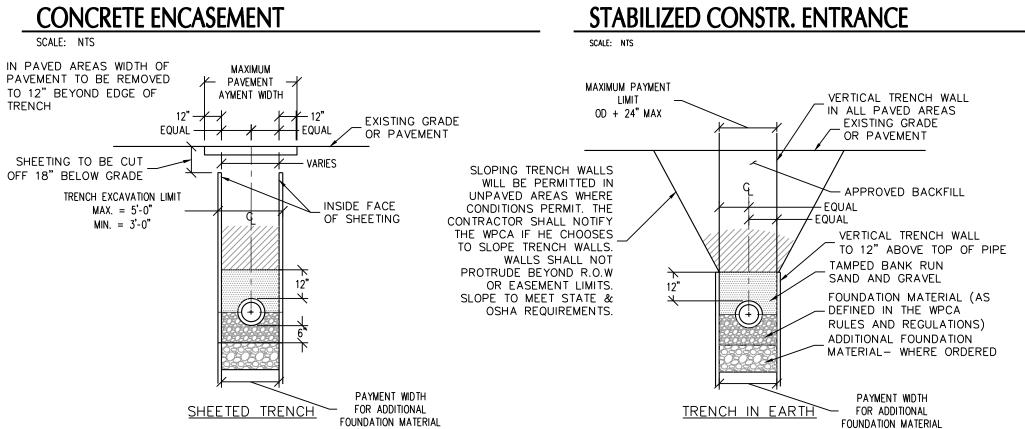

			OF CONNECTION OF	
10/26/16	Revised per Inland Wetland Commission Comments	1.	No. 19212	40/00/40
Date	Description	No.	SIGNATURE NALENGIA	10/26/16 DATE SIGNE
REVISIONS			W. CHARLES UTSCHIG PROFESSIONAL ENGINEER CT Lic.	

LBS. PER ACRE PER 1000 S.F.

ROLLINGWOOD CONDOMINIUM SEWER IMPROVEMENTS

FAIRFIELD COUNTY

rawing Title

190011002 **AUGUST 5, 2016 DETAILS** Scale N.T.S. Drawn By | Checked By

Drawing No.

CS501

CU TOWN OF BROOKFIELD Submission Date Sheet 7 of 7 **CONNECTICUT** Filename: \langan.com\data\WP\data0\190011002\Cadd Data - 190011002\SheetFiles\SITE PLAN\190011002-CS501-0101.dwg Date: 10/25/2016 Time: 17:17 User: ekingsbury Style Table: Langan.stb Layout: ARCHD-BL